City of Tacoma **Environmental Services Department**

LEACH CREEK STORMWATER HOLDING BASIN MODIFICATIONS DRAFT BID SET



Project No. ENV-03031-01 Spec Number ES22-0242F

Brown AND Caldwell

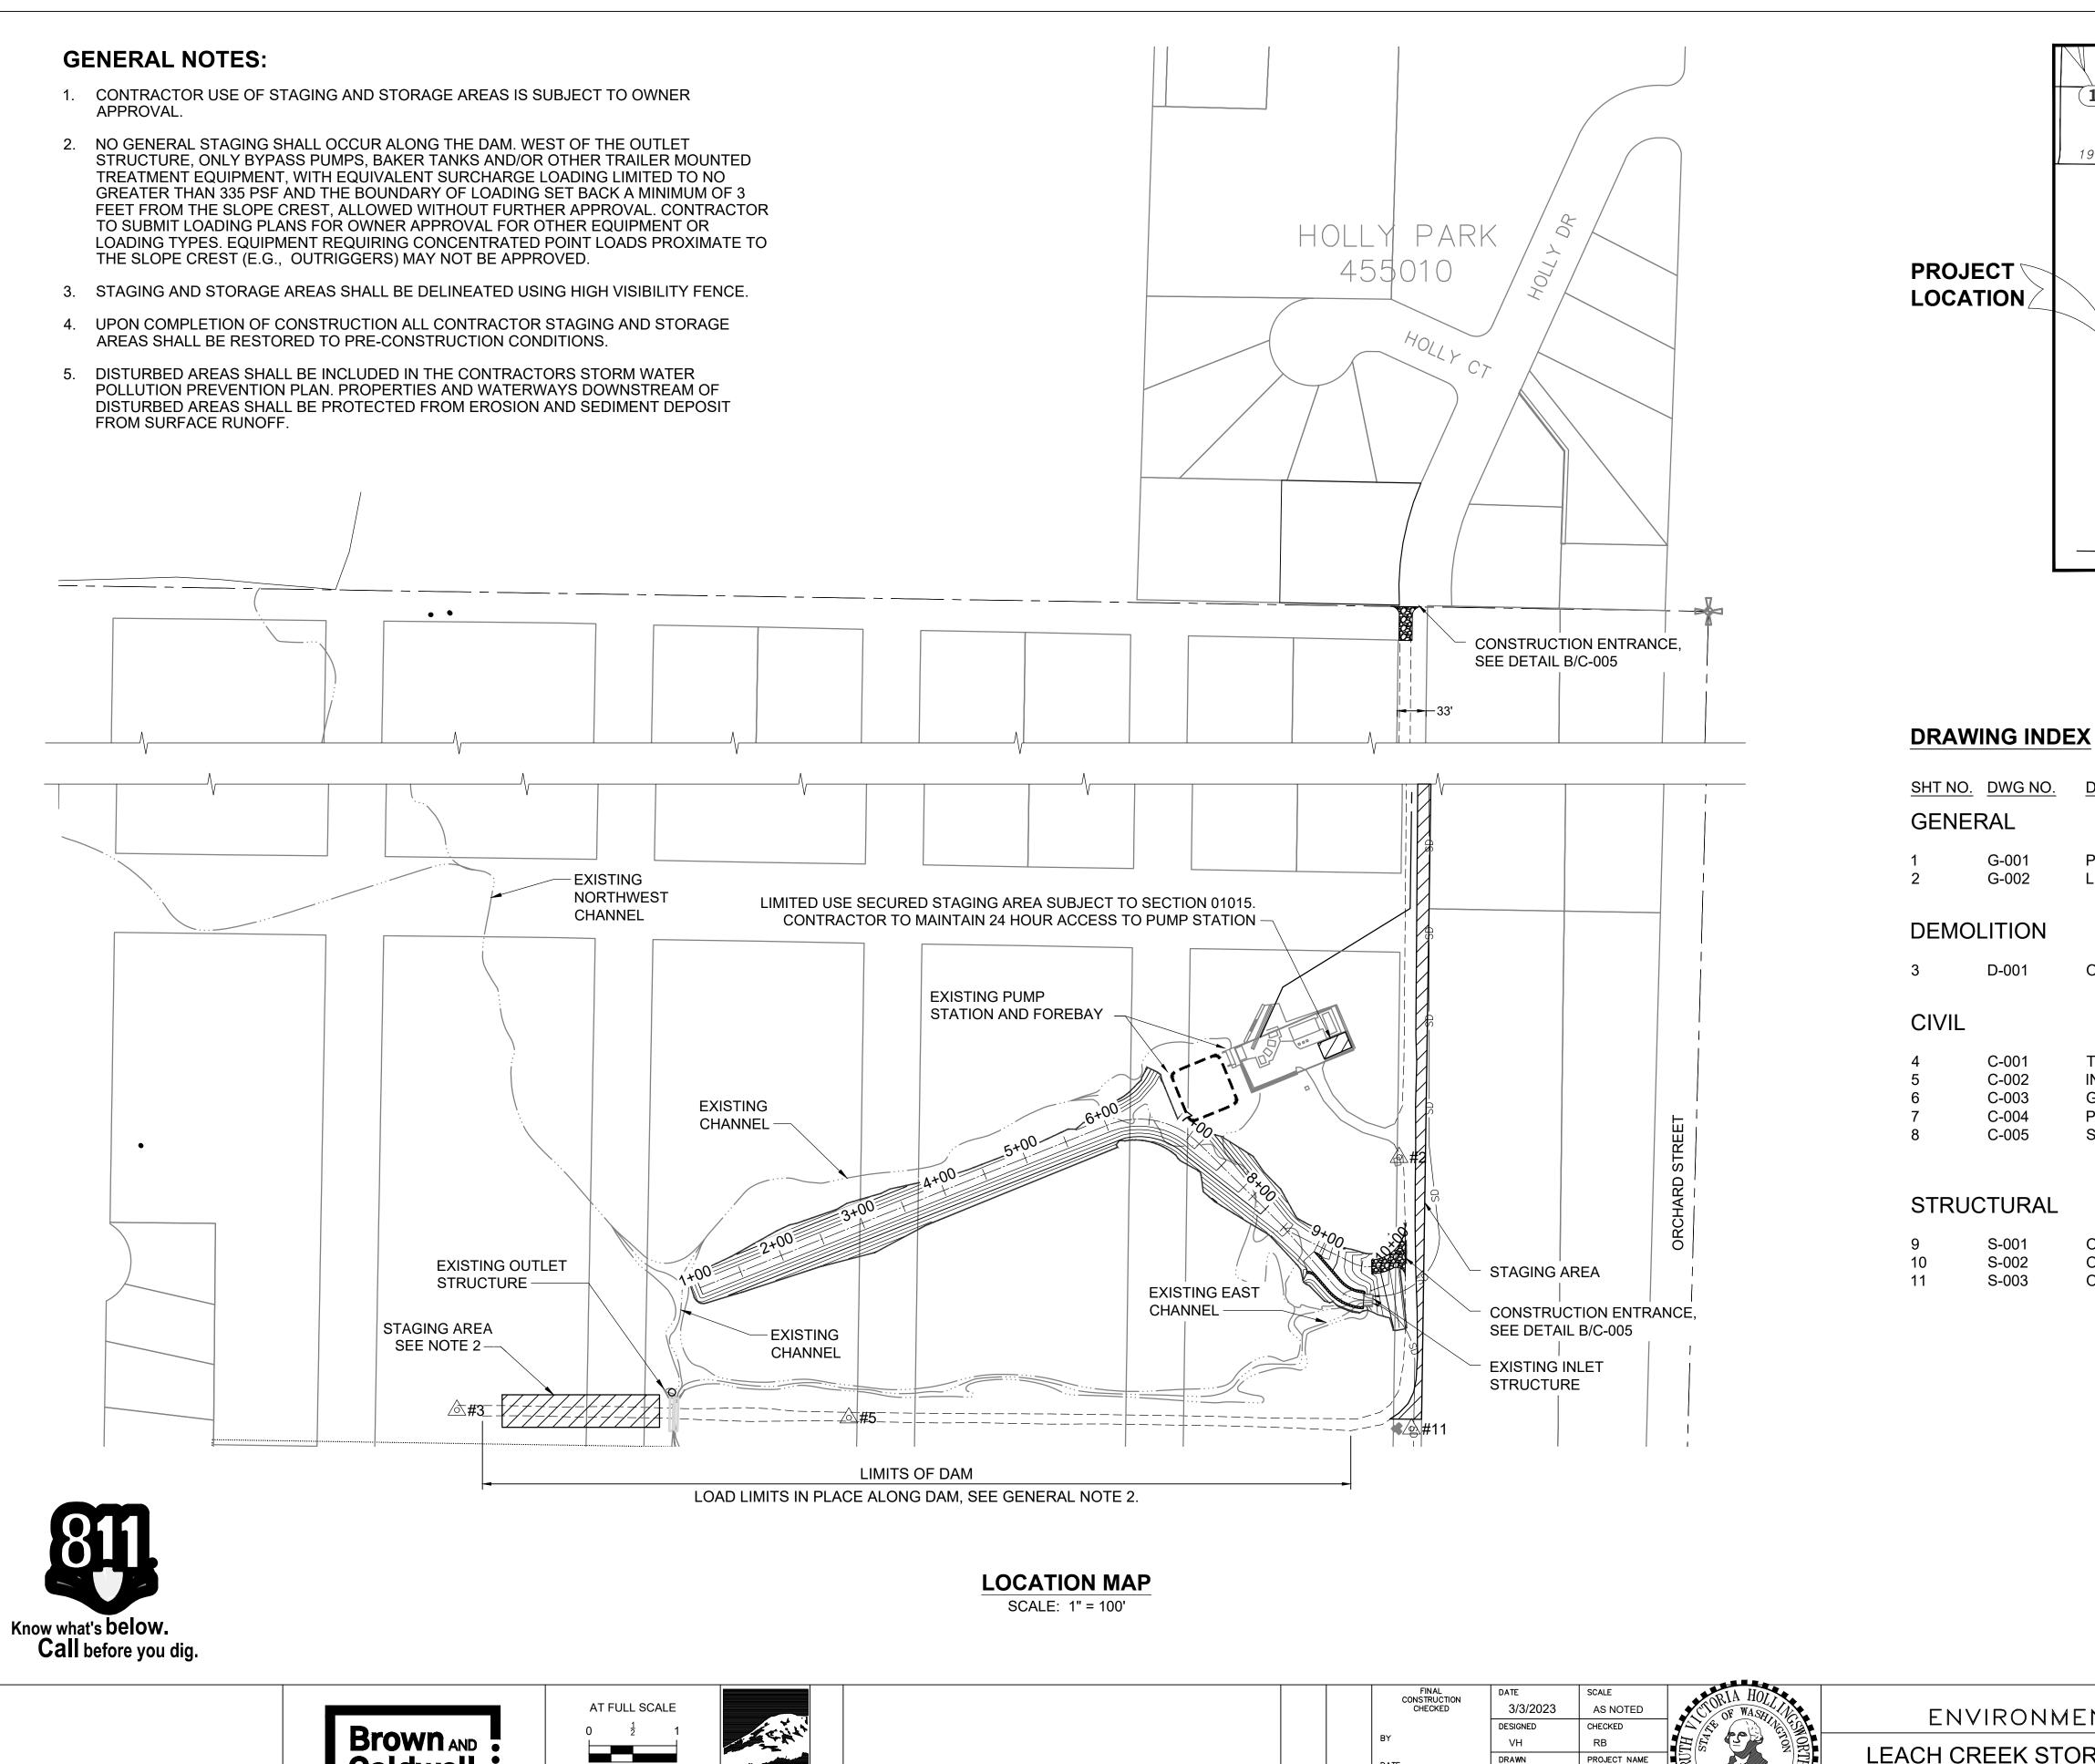
- APPROVAL.
- TREATMENT EQUIPMENT, WITH EQUIVALENT SURCHARGE LOADING LIMITED TO NO GREATER THAN 335 PSF AND THE BOUNDARY OF LOADING SET BACK A MINIMUM OF 3 TO SUBMIT LOADING PLANS FOR OWNER APPROVAL FOR OTHER EQUIPMENT OR LOADING TYPES. EQUIPMENT REQUIRING CONCENTRATED POINT LOADS PROXIMATE TO THE SLOPE CREST (E.G., OUTRIGGERS) MAY NOT BE APPROVED.
- AREAS SHALL BE RESTORED TO PRE-CONSTRUCTION CONDITIONS.
- POLLUTION PREVENTION PLAN. PROPERTIES AND WATERWAYS DOWNSTREAM OF DISTURBED AREAS SHALL BE PROTECTED FROM EROSION AND SEDIMENT DEPOSIT FROM SURFACE RUNOFF.

Caldwell


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NO



			FINAL CONSTRUCTION	DATE	SCALE	OBIA HOL			
			CHECKED	3/3/2023	AS NOTED	OF WASH	ENVIRONMEI		
				DESIGNED	CHECKED		ENVIRONMEI		
			BY	VH	RB	A DIA PARA			
			DATE	DRAWN	PROJECT NAME	ON ON THE ON	LEACH CREEK STOR		
				кт		49555			
			FIELD BOOKS	DRAWING NAME	•	CHA REGISTERED CAN			
REVISION	DATE	APPD		158869-G-001.dwg		158869-G-001.dwg		STONAL ENG	PROJECT LOCATI
		1							



DRAWING TITLE

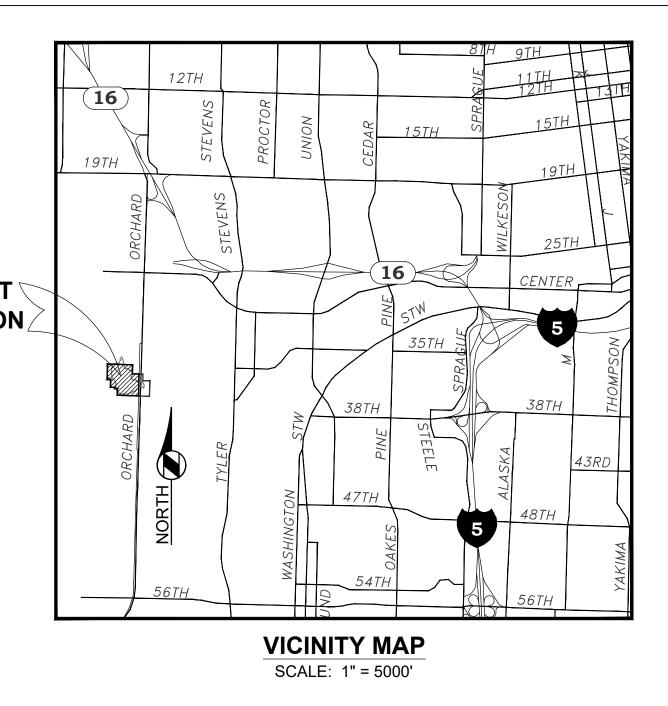PROJECT LOCATION, VICINITY MAP, AND DRAWING INDEX LEGEND


OUTLET STRUCTURE DEMOLITION PLAN


TEMPORARY EROSION AND SEDIMENT CONTROL, BYPASS, GRADING AND LAYOUT INFLOW CHANNEL REROUTING AND ACCESS RAMP GRADING SECTIONS PLANTING PLAN AND DETAILS SITE DETAILS


S-001

OUTLET STRUCTURE GENERAL STRUCTURAL NOTES, ABBREVIATION AND LEGEND OUTLET STRUCTURE PLANS OUTLET STRUCTURE SECTIONS AND DETAILS - 1

NORTH	
0 100 SCALE IN F	200 EET
CITY OF TACOMA	DRAWING NO.
ENTAL SERVICES DEPARTMENT	G-001
RMWATER HOLDING BASIN MODIFICATIONS	ES22-0242F ENV-03031-01
TION, VACINITY MAP AND DRAWING INDEX	sheet no. sheet 1 of 11
	·

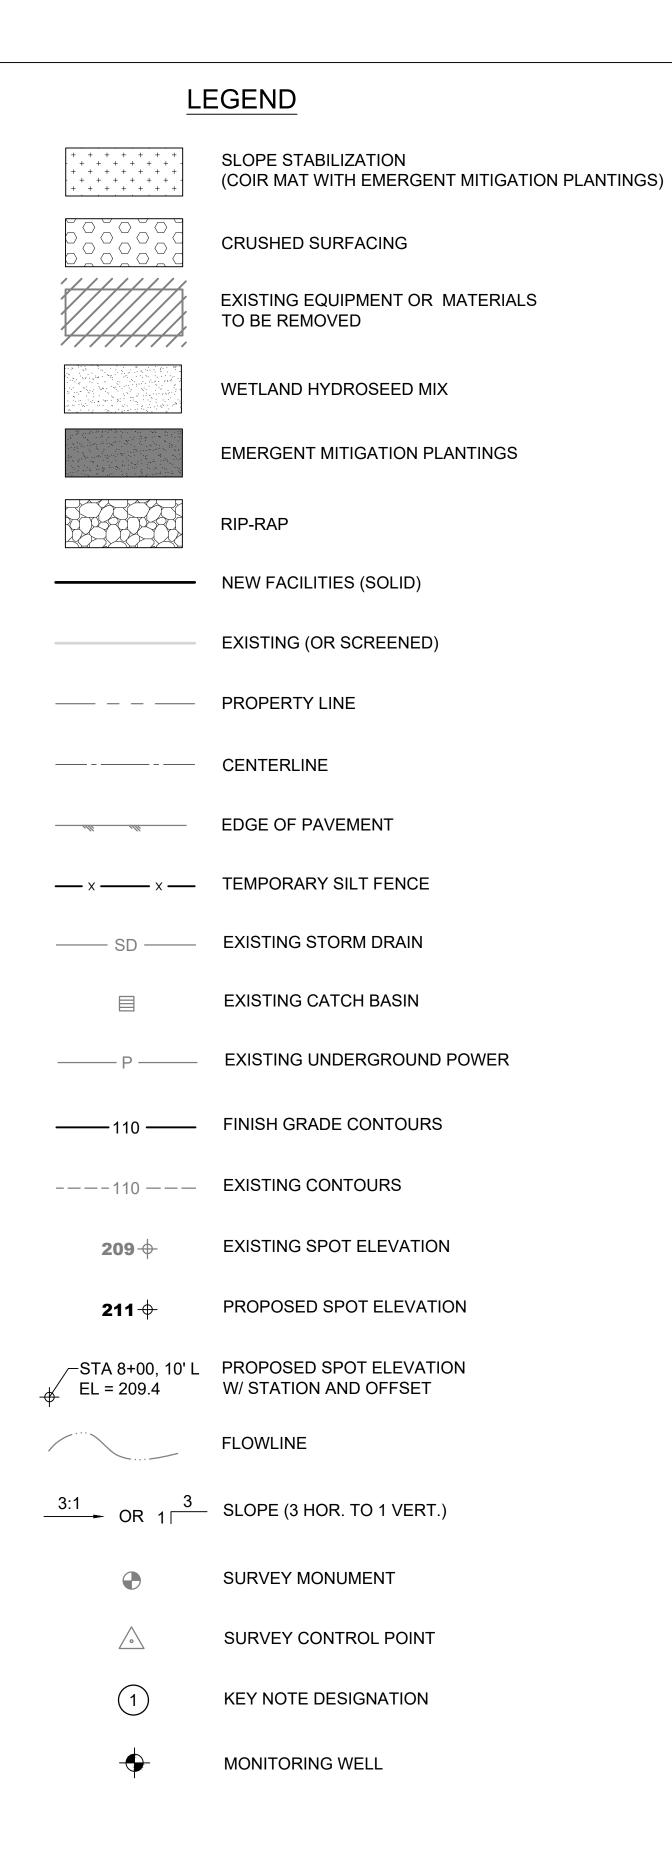

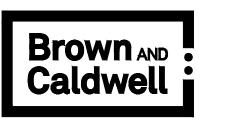

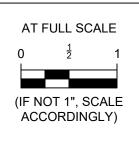



ABBREVIATIONS

AL APPX ASSY AVE	ALUMINUM, ALUM APPROXIMATE(LY) ASSEMBLY VENUE	OC OD OPGN	ON CENTERS OUTSIDE AIR DIAMETER OPENING
		PVT	PAVEMENT
BLDG BOP BOT	BUILDING BOTTOM OF PIPE, BACK OF PIPE BOTTOM	R RAD RO	RADIUS, RISER RADIUS ROUGH OPENINGS
€ CND CONT CONTD CV	CENTERLINE CONDUIT CONTINUOUS CONTINUED CONTROL VALVE	SCH SE SEC SHT SIM	SCHEDULE SOUTHEAST SECOND SHEET SIMILAR
DB DIA DIP DWG(S)	DUCT BANK DIAMETER DUICTILE IRON PIPE DRAWING(S)	SL SLG SPG SS	SLOPE SLIDE GATE SPACING STAINLESS STEEL, SANITARY SEWER, SPEED SELECTOR,
FAB FND FR FT	FABRICATE(D), FABRICATION FOUNDATION FRAME FLASH TANK, FEET	STL STRUCT	SUSPENDED SOLIDS STEEL STRUCTURAL
GALV GEN GPD GPM GRD GRTG	GALVANIZED GENERAL GALLONS PER DAY GALLONS PER MINUTE GRADE GRATING	T/C THD'D TOP TOS TPG TYP	TOP OF CURB THREADED TOP OF PIPE TOP OF STEEL TOPPING TYPICAL
H HOR HR	HIGH, HORIZONTAL HORIZONTAL HANDRAIL, HEAT RESERVIOR	UG U/P US	UNDERGROUND UTILITY POLE UTILITY STATION
ID INV INV EL	INSIDE DIAMETER INVERT, INVERT ELEVATION INVERT ELEVATION	VAR VERT(S) W/	VARIES, VARIABLE VERTICAL(S) WITH
JB JCT	JUNCTION BOX JUNCTION	W/O WSTP WT WWF	WITOUT WATERSTOP WATERTIGHT, WEIGHT WELDED WIRE FABIRC,
LEV	LEVEL		WET WEATHER FLOW
MAINT MAT'L MAX MECH MFR MG MGD	MAINTENANCE MATERIAL MAXIMUM MECHANICAL MANUFACTURER MILLION GALLONS MILLION GALLONS PER DAY		NUMBER, POUNDS AND AT DIAMETER, PHASE AL PRESENTED ON THIS DRAWING RENCE USE. SOME OF THE DETAILS
N NE NOM NW	NEUTRAL, NORTH NORTHEAST NOMINAL NORTHWEST		TION PRESENTED ON THIS AY NOT BE REQUIRED AS PART OF ACT.

			FINAL CONSTRUCTION	DATE	SCALE	ABIA HOLE	
			CHECKED	3/3/2023	AS NOTED	OF WASH	ENVIRON
				DESIGNED	CHECKED		
			BY	VH	RB		
			DATE	DRAWN	PROJECT NAME		LEACH CREEK S
				KT		49555	
			FIELD BOOKS	DRAWING NAME		A REGISTERED STA	
REVISION	DATE	APPD		158869-	-G-002.dwg	O'SIONAL ENG	
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now what's below.	

Know what's **below. Call** before you dig.

CITY	OF TACOMA		DI	RAWING NO.		
		DEPARTMENT		G-(002	
			w	BS NO.		
STORMWAT		ES22-0242F				
	CIVII			ENV-0	303	1-01
		TIONO	SI	HEET NO.		
LEGEND A	ND ABBREVIA	TIONS	SI	неет 2	OF	11



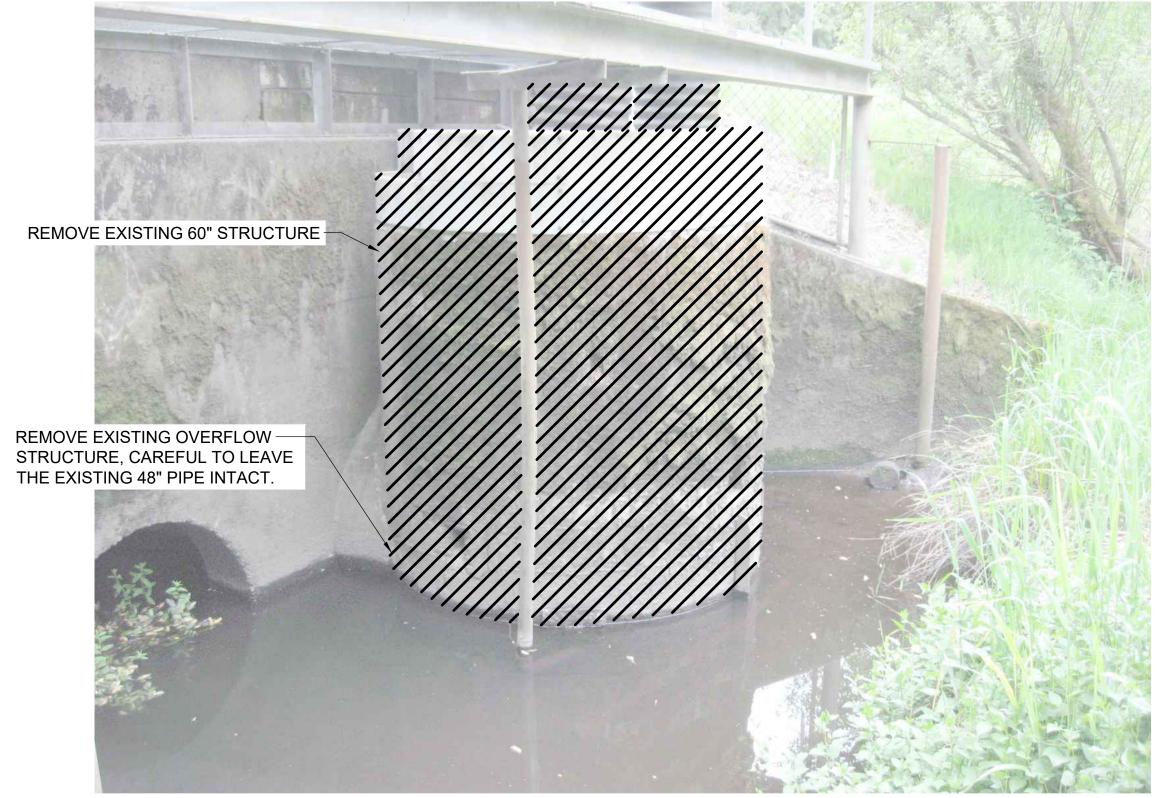
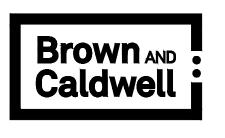
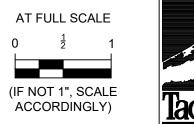
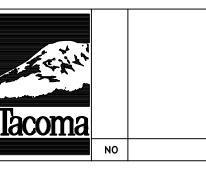


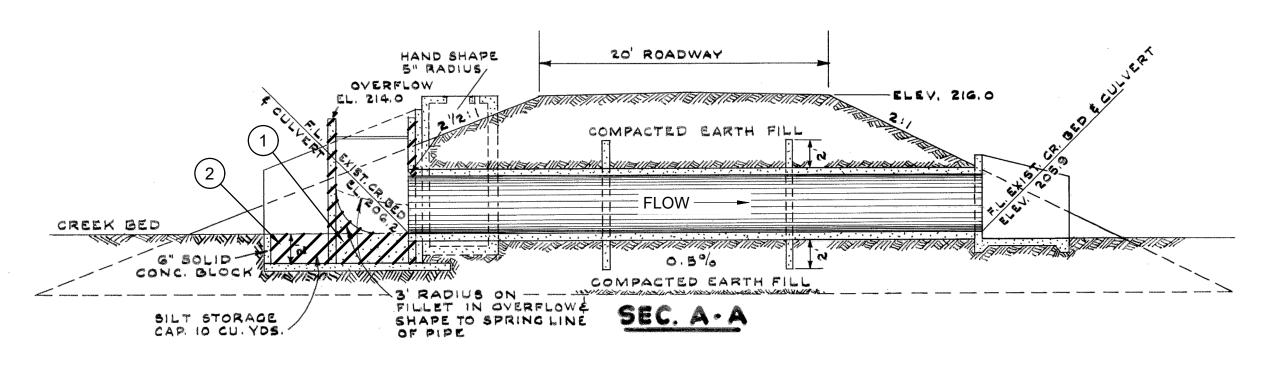


PHOTO 3: LOOKING SOUTHWEST










SOURCE: 1960 RECORD DRAWINGS FOR: LEACH CREEK HOLDING BASIN: DAM AND STRUCTURES

> **EXISTING CONDITION** SECTION SCALE: NTS

			FINAL CONSTRUCTION CHECKED	date 3/3/2023	SCALE AS NOTED	CTORIA HOLL	ENVIRON
				DESIGNED	CHECKED		ENVIRON
			BY	VH	RB	ELD STREET	
			DATE	DRAWN	PROJECT NAME		LEACH CREEK S
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			FIELD BOOKS	DRAWING NAME		CHE REGISTERED LITE	
REVISION	DATE	APPD		158869-D-001.dwg		OSIONAL END	001
	•	•		•			

- (2) REMOVE ACCUMULATED SEDIMENT FROM FOREBAY.
- (3) HINGED PORTION OF GRATING TO REMAIN. SEE S-002.
- (4) NOT USED.
- EXISTING HANDRAIL TO REMAIN.
- EXISTING GRATING IS TACK-WELDED TO THE SUPPORTS AND ALONG PANEL JOINTS AND WILL REQUIRE CUTTING OUT WITHOUT DAMAGE TO THE SUPPORTING ANGLES AND BEAM.

CITY OF TACOMA	DRAWING NO.
NMENTAL SERVICES DEPARTMENT	D-001
STORMWATER HOLDING BASIN MODIFICATIONS	ES22-0242F ENV-03031-01
TLET STRUCTURE DEMOLITION PLAN	sheet no. sheet 3 of 11

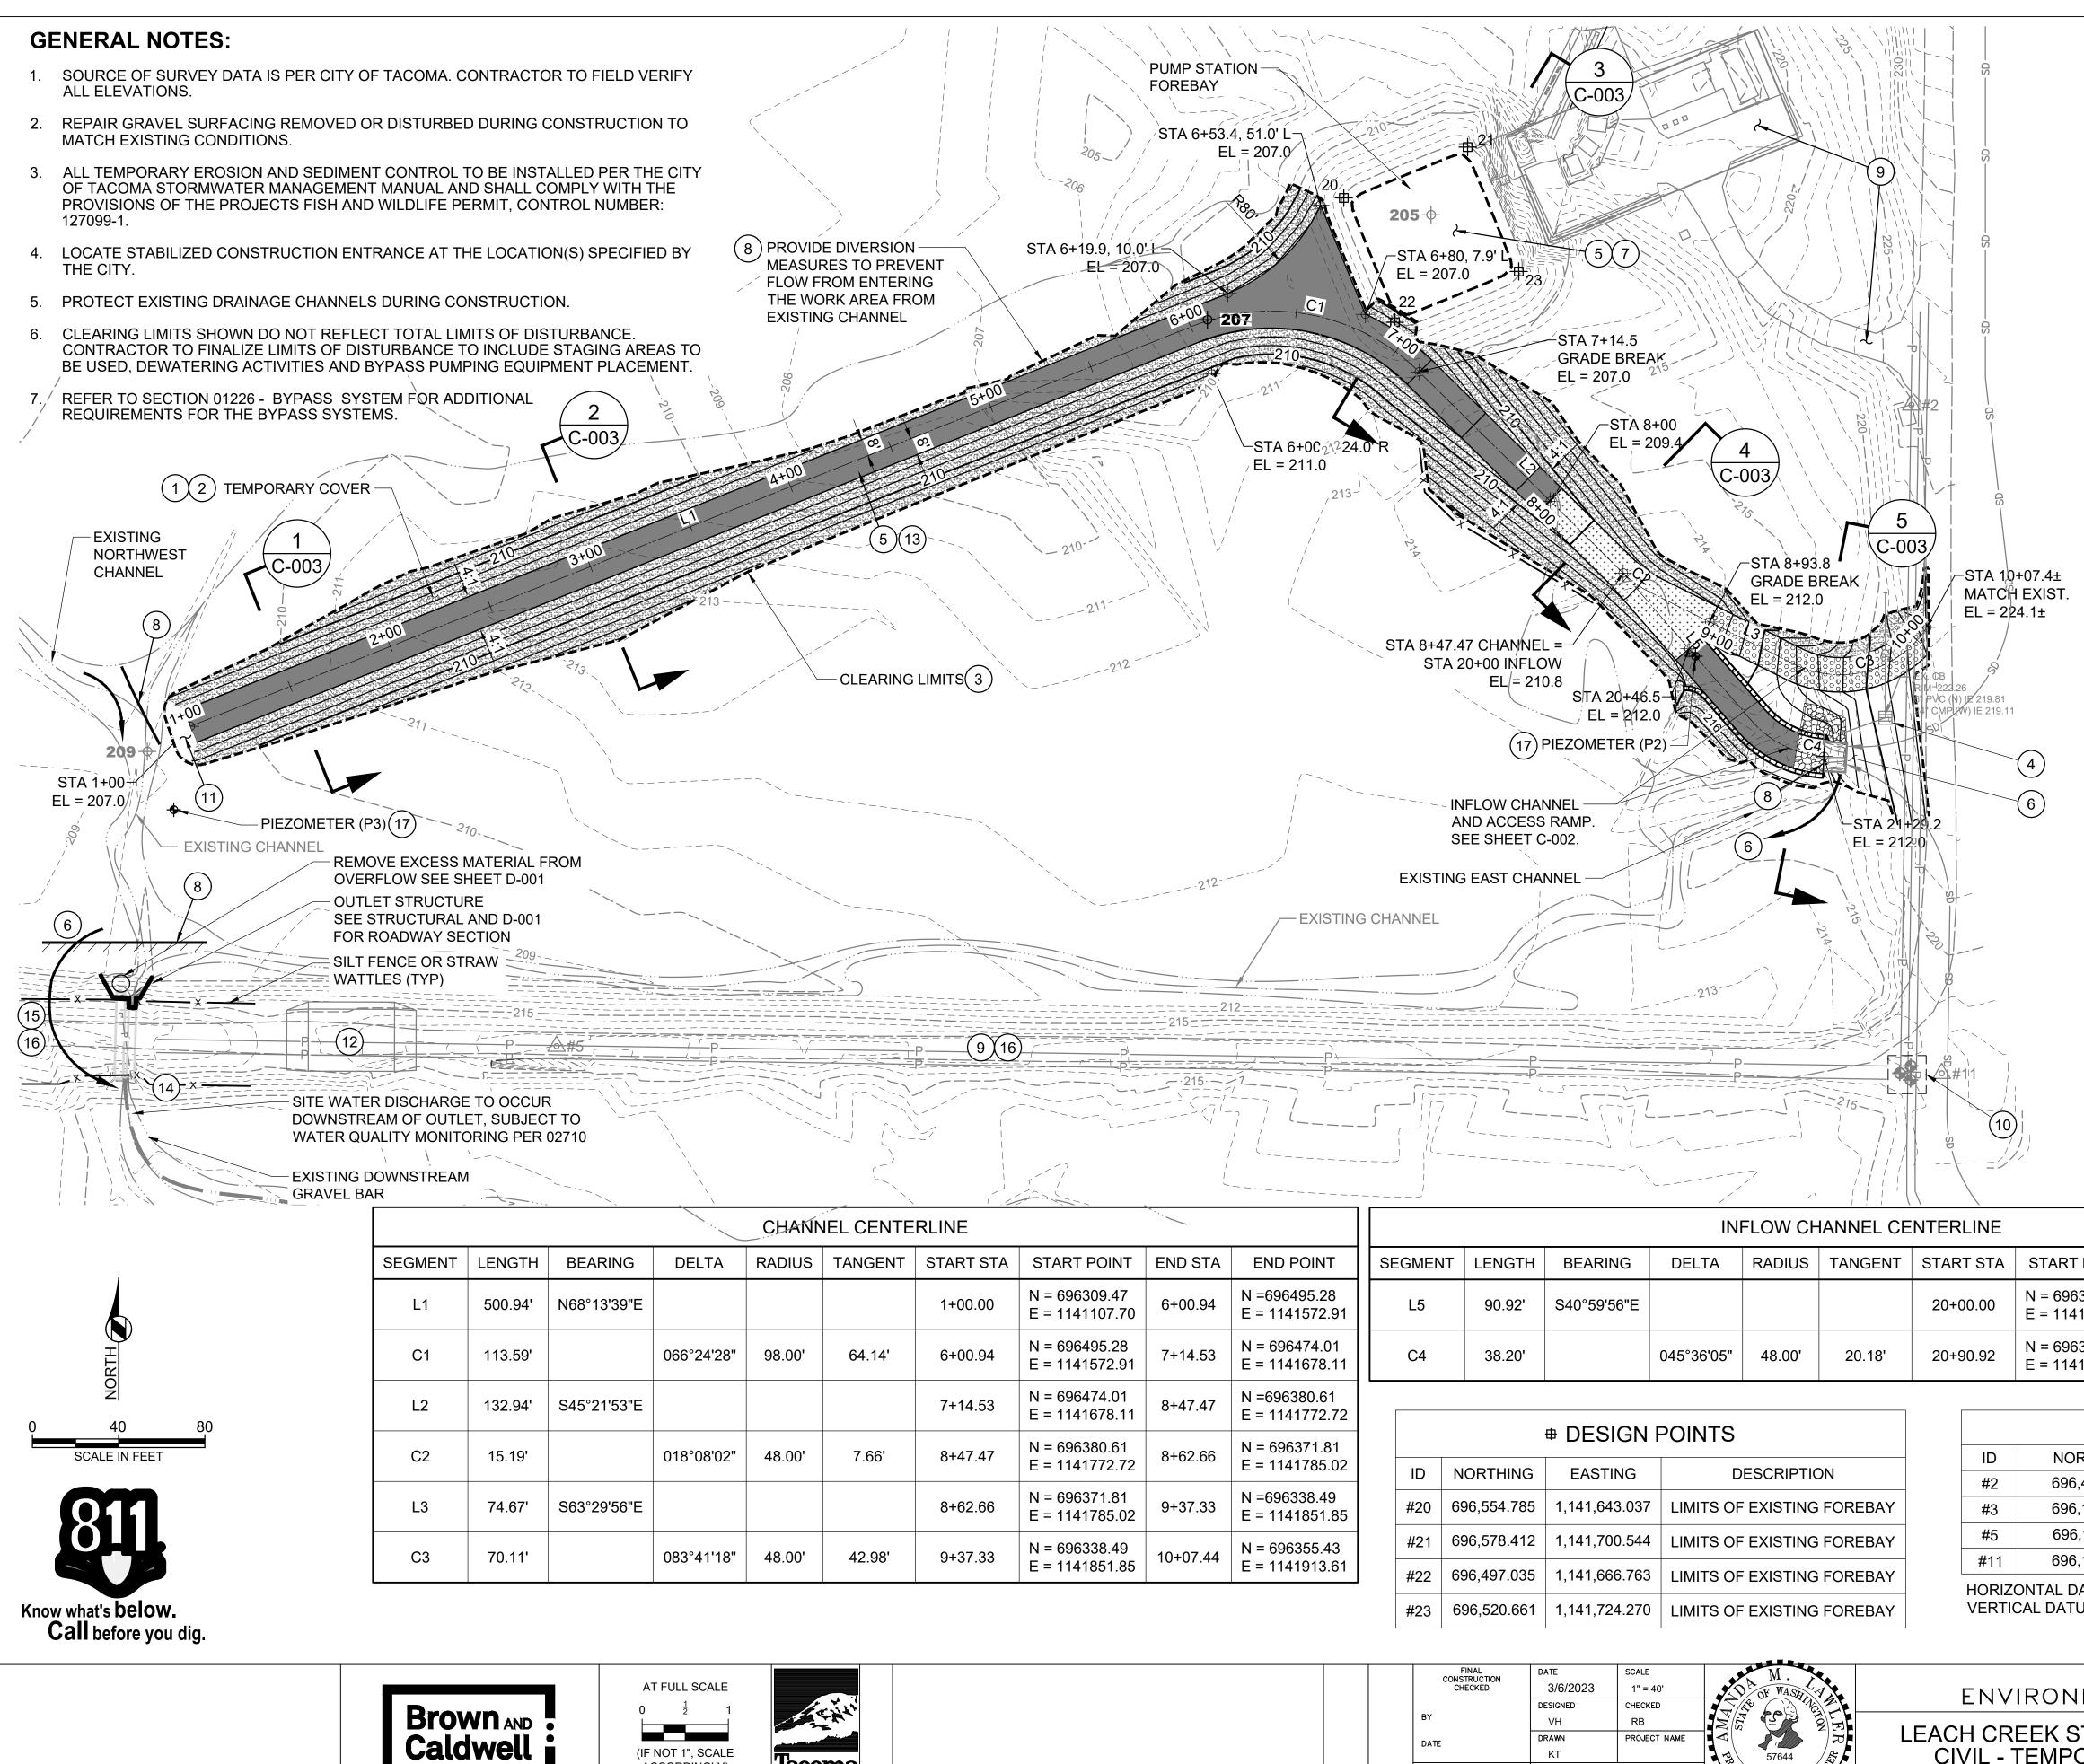

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(IF NOT 1", SCALE

ACCORDINGLY)

	INFLOW CHANNEL CENTERLINE										
SEGMENT	LENGTH	BEARING	DELTA	RADIUS	TANGENT	START STA	START POINT	END STA	END POINT		
L5	90.92'	S40°59'56"E				20+00.00	N = 696380.62 E = 1141772.73	20+90.92	N =696312.00 E = 1141832.38		
C4	38.20'		045°36'05"	48.00'	20.18'	20+90.92	N = 696312.00 E = 1141832.38	21+29.13	N = 696295.57 E = 1141865.76		

			DECODIDITION	ID	
ID	NORTHING	EASTING	DESCRIPTION	#2	
#20	696,554.785	1,141,643.037	LIMITS OF EXISTING FOREBAY	#3	
#21	696,578.412	1,141,700.544	LIMITS OF EXISTING FOREBAY	#5	
				#11	
#22	696,497.035	1,141,666.763	LIMITS OF EXISTING FOREBAY		ר כ
#23	696,520.661	1,141,724.270	LIMITS OF EXISTING FOREBAY	VERTIC	-

STA	START POINT	END STA	END POINT
.00	N = 696309.47 E = 1141107.70	6+00.94	N =696495.28 E = 1141572.91
.94	N = 696495.28 E = 1141572.91	7+14.53	N = 696474.01 E = 1141678.11
.53	N = 696474.01 E = 1141678.11	8+47.47	N =696380.61 E = 1141772.72
.47	N = 696380.61 E = 1141772.72	8+62.66	N = 696371.81 E = 1141785.02
.66	N = 696371.81 E = 1141785.02	9+37.33	N =696338.49 E = 1141851.85
.33	N = 696338.49 E = 1141851.85	10+07.44	N = 696355.43 E = 1141913.61

			FINAL CONSTRUCTION	DATE	SCALE	M .	
			CHECKED	3/6/2023	1" = 40'	OF WASH	ENVIRON
				DESIGNED	CHECKED		
			BY	VH	RB	NAK STATION	
			DATE	DRAWN	PROJECT NAME		LEACH CREEK S
				КТ		57644	CIVIL - TEMP
			FIELD BOOKS	DRAWING NAME		REGISTERED T	
REVISION	DATE	APPD		158869-0	C-001.dwg	SIONAL ENG	

KEY NOTES:

\frown	
(1)	APPLY 3" OF COMPOSTED MULCH TO ALL DISTURBED AREAS AS TEMPORARY COVER. ERODABLE SOILS SHALL BE COVERED WITHIN THE TIME PERIOD SPECIFIED IN WSDOT SECTION 8-01.3(1).
2	PRIOR TO ALLOWING FLOW IN THE CHANNEL, APPLICATION OF ALL PERMANENT SEEDING, PLANTING, AND EROSION CONTROL BLANKETS MUST BE COMPLETE.
(3)	DELINEATE CLEARING LIMITS WITH HIGH VISIBILITY PLASTIC FENCE.
(4)	INSTALL STORM DRAIN INLET PROTECTION.
5	INSTALL DEWATERING SYSTEM PER SECTION 02715. SITE WATER SHALL BE DISCHARGED DOWNSTREAM OF THE OUTLET STRUCTURE AND MUST COMPLY WITH SECTION 02710 SITE WATER DISCHARGE.
6	CONTRACTOR TO PROVIDE BYPASS PUMPING AT THIS LOCATION PER 01126 BYPASS.
7	REMOVE EXCESS MATERIAL AND DEBRIS TO ORIGINAL DESIGN ELEVATION OF 205. SEE SPECIFICATION SECTION 01010.
8	CONSTRUCT TEMPORARY WATERPROOF COFFERDAM IN ORDER TO BYPASS FLOW AWAY FROM WORK AREA DURING CONSTRUCTION PER SECTION 01126.
9	MAINTAIN 24-HOUR ACCESS TO EXISTING PUMP STATION AND OUTLET STRUCTURE AT ALL TIMES.
(10)	EXISTING WELLS AND BOLLARDS. PROTECT IN PLACE.
(11)	NEW CHANNEL TO MATCH EXISTING GRADES WITHIN CLEARING LIMITS. CONTRACTOR SHALL TAPER GRADING TO FACILITATE SMOOTH CHANNEL TRANSITION. INSTALL TEMPORARY COFFER DAM OR SANDBAGS TO PROTECT NEW CHANNEL PRIOR TO INSTALLATION OF EROSION CONTROL BLANKETS.
(12)	PROTECT OVERFLOW SPILLWAY STRUCTURE BY DISTRIBUTING VEHICLE LOADS PER SECTION 02100.
(13)	SOFT SOILS TO BE ENCOUNTERED DURING EXCAVATION. CONTRACTOR TO UTILIZE STABILIZING TRACK MATS WHERE NECESSARY.
(14)	ALL WORK WITHIN THE BASIN SHALL OCCUR WITH THE OUTLET PIPES CLOSED OR PLUGGED TO ISOLATE THE BASIN FROM LEACH CREEK PER ARMY CORPS OF ENGINEERS PERMIT NWS-2011-859-WRD.
(15)	AREA WEST OF OUTLET STRUCTURE AVAILABLE FOR BYPASS AND TREATMENT RELATED EQUIPMENT SEE G-001


(16) NO GENERAL STAGING SHALL OCCUR ALONG THE DAM. WEST OF THE OUTLET STRUCTURE AS INDICATED, ONLY BYPASS PUMPS, BAKER TANKS AND/OR OTHER TRAILER MOUNTED TREATMENT EQUIPMENT, WITH EQUIVALENT SURCHARGE LOADING LIMITED TO NO GREATER THAN 335 PSF AND THE BOUNDARY OF LOADING SET BACK A MINIMUM OF 3 FEET FROM THE SLOPE CREST, ALLOWED WITHOUT FURTHER APPROVAL. CONTRACTOR TO SUBMIT LOADING PLANS FOR OWNER APPROVAL FOR OTHER EQUIPMENT OR LOADING TYPES. EQUIPMENT REQUIRING CONCENTRATED POINT LOADS PROXIMATE TO THE SLOPE CREST (E.G., OUTRIGGERS) MAY NOT BE APPROVED.


(17) EXISTING PIEZOMETER AVAILABLE FOR CONTRACTOR USE. SEE SECTION 02715.


▲ SURVEY CONTROL POINTS								
RTHING	EASTING	ELEVATION	DESCRIPTION					
,458.618	1,141,906.423	225.73	"X" NE COR VAULT					
,169.796	1,140,829.824	218.41	BRASSIE/CONC W END DIKE					
,161.011	1,141,277.701	218.03	R&C APPROX CL GRAVEL RD					
,148.402	1,141,920.544	218.51	SBM IDAHO & DIKE					

ONTAL DATUM: STATE PLANE GRID COORDINATE SYSTEM (NAD83/91) SOUTH ZONE. CAL DATUM: NGVD 29


CITY OF TACOMA NMENTAL SERVICES DEPARTMENT	drawing no.		
	WBS NO. ES22-0242F ENV-03031-01		
BYPASS GRADING AND LAYOUT	sheet no. _{Sheet} 4 _{of} 12		

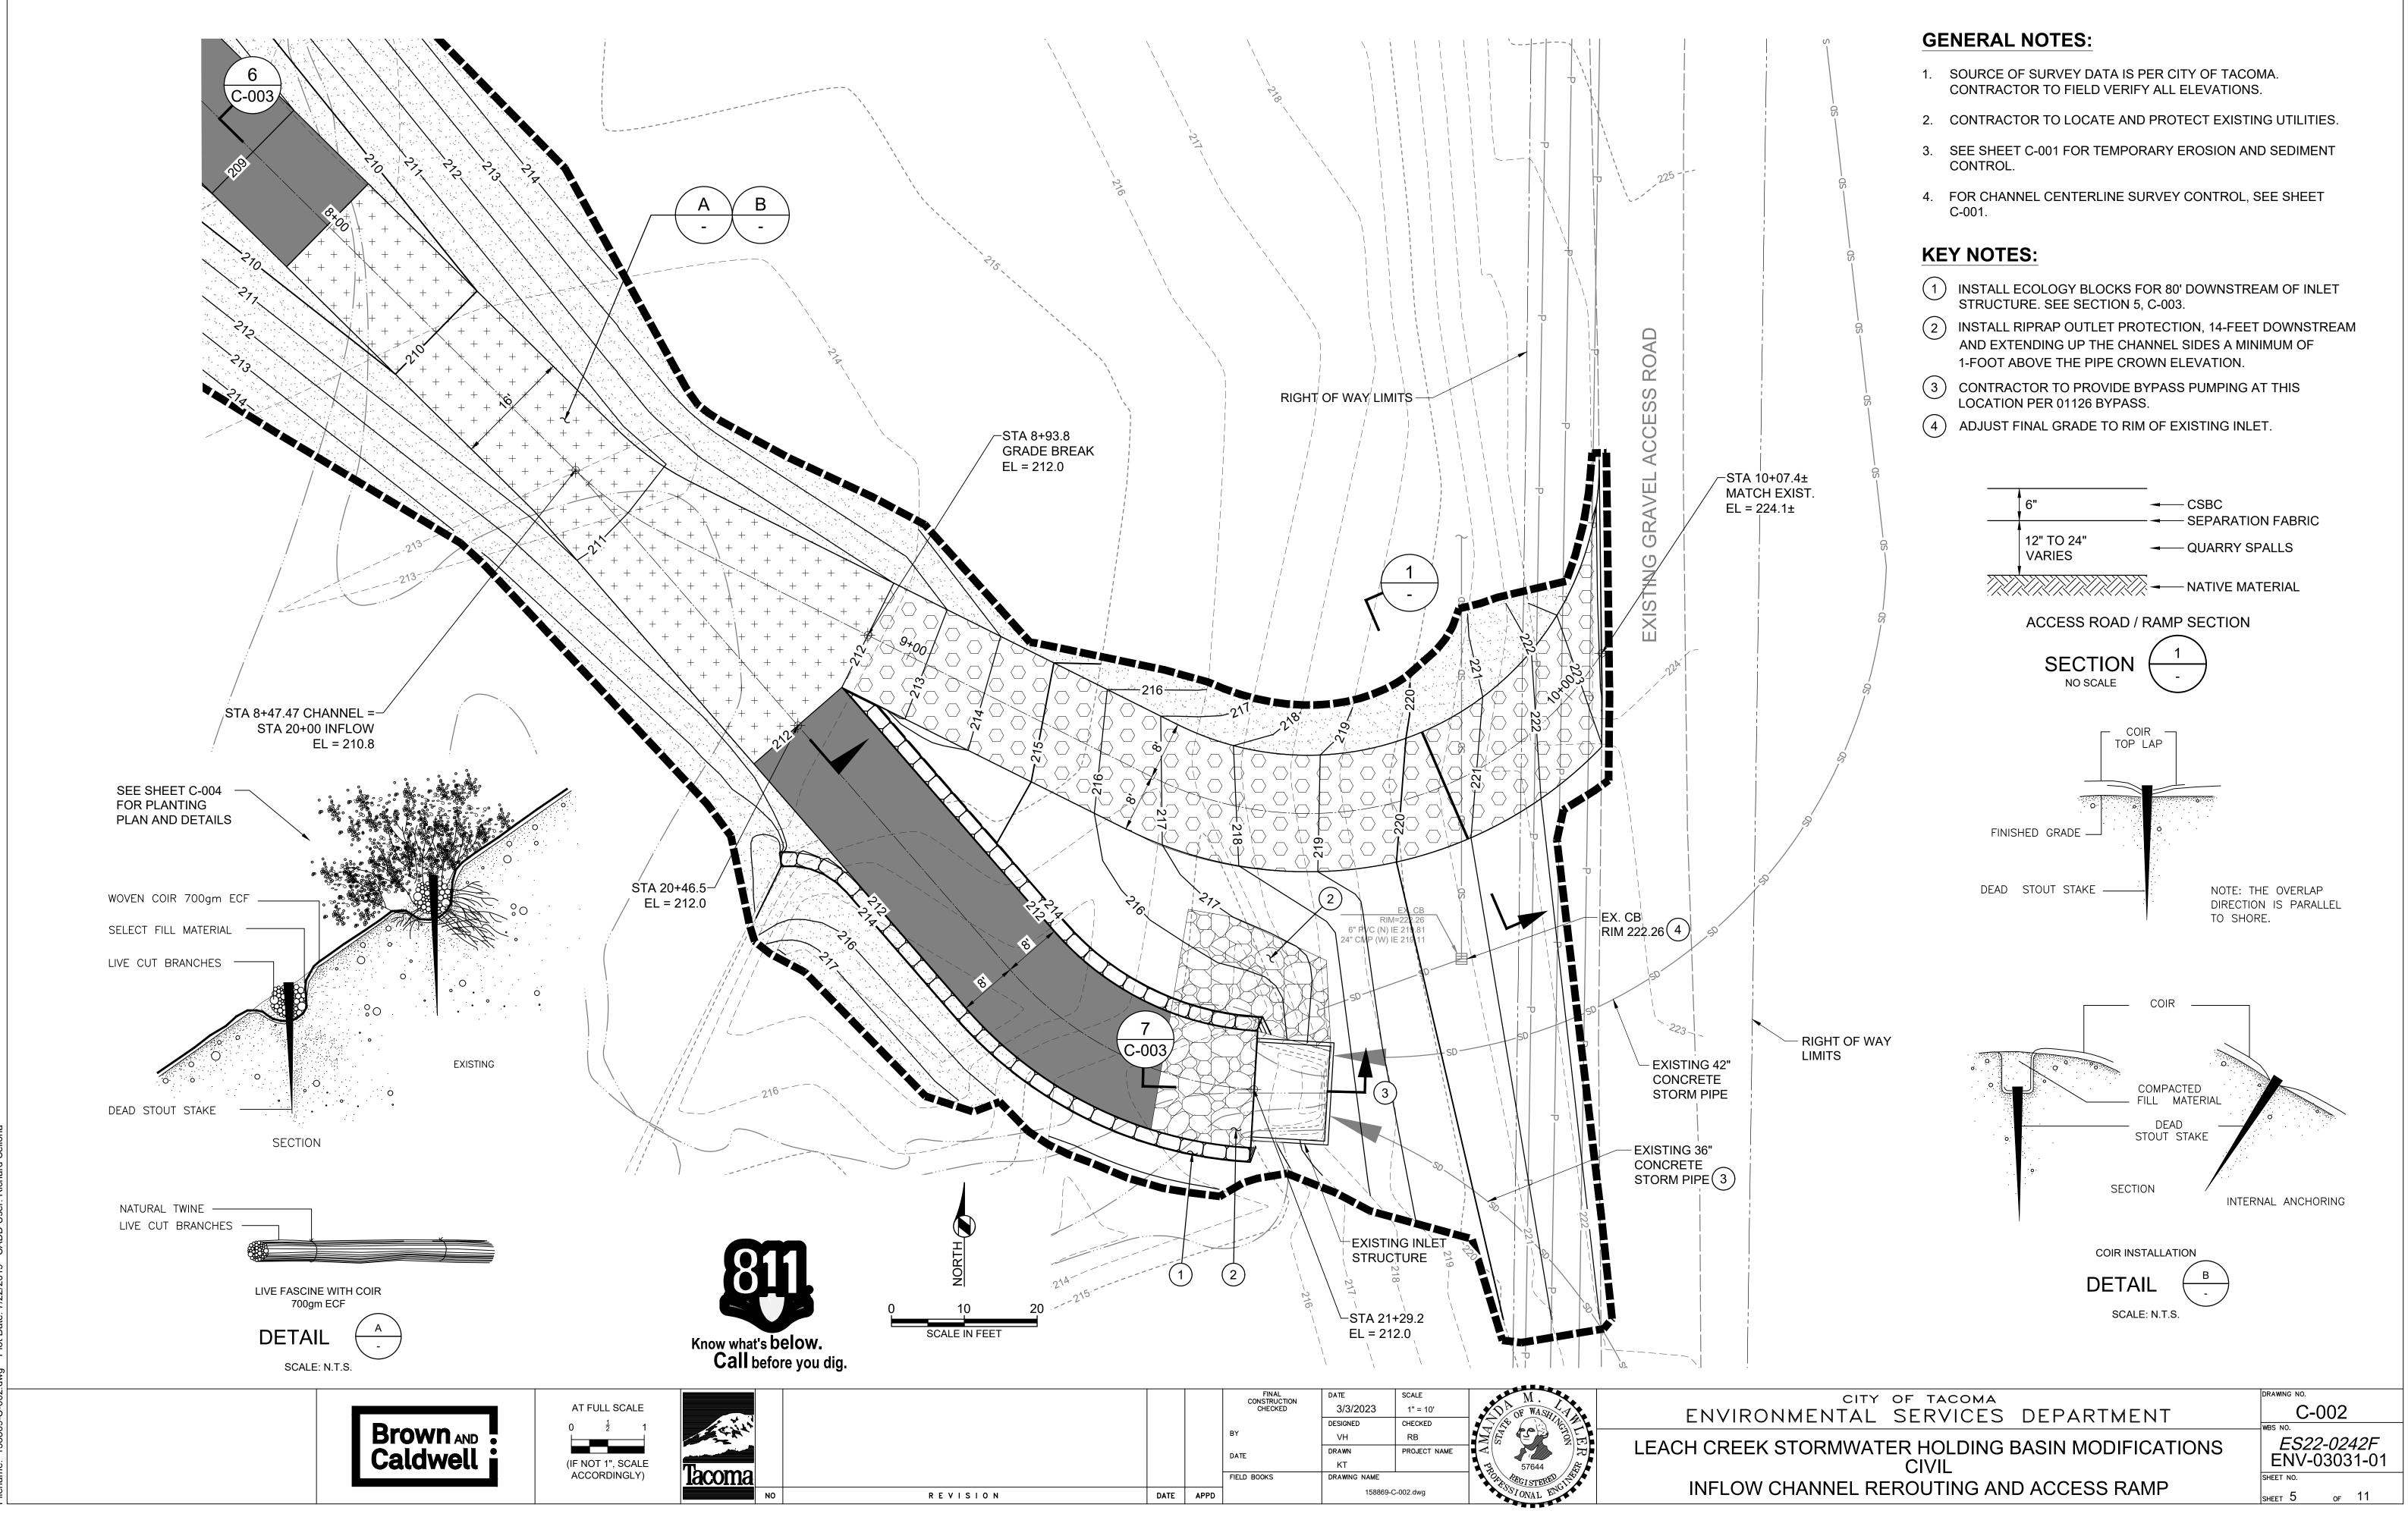

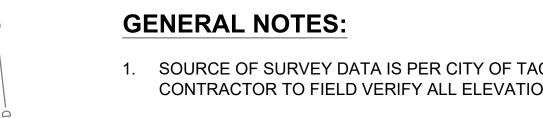

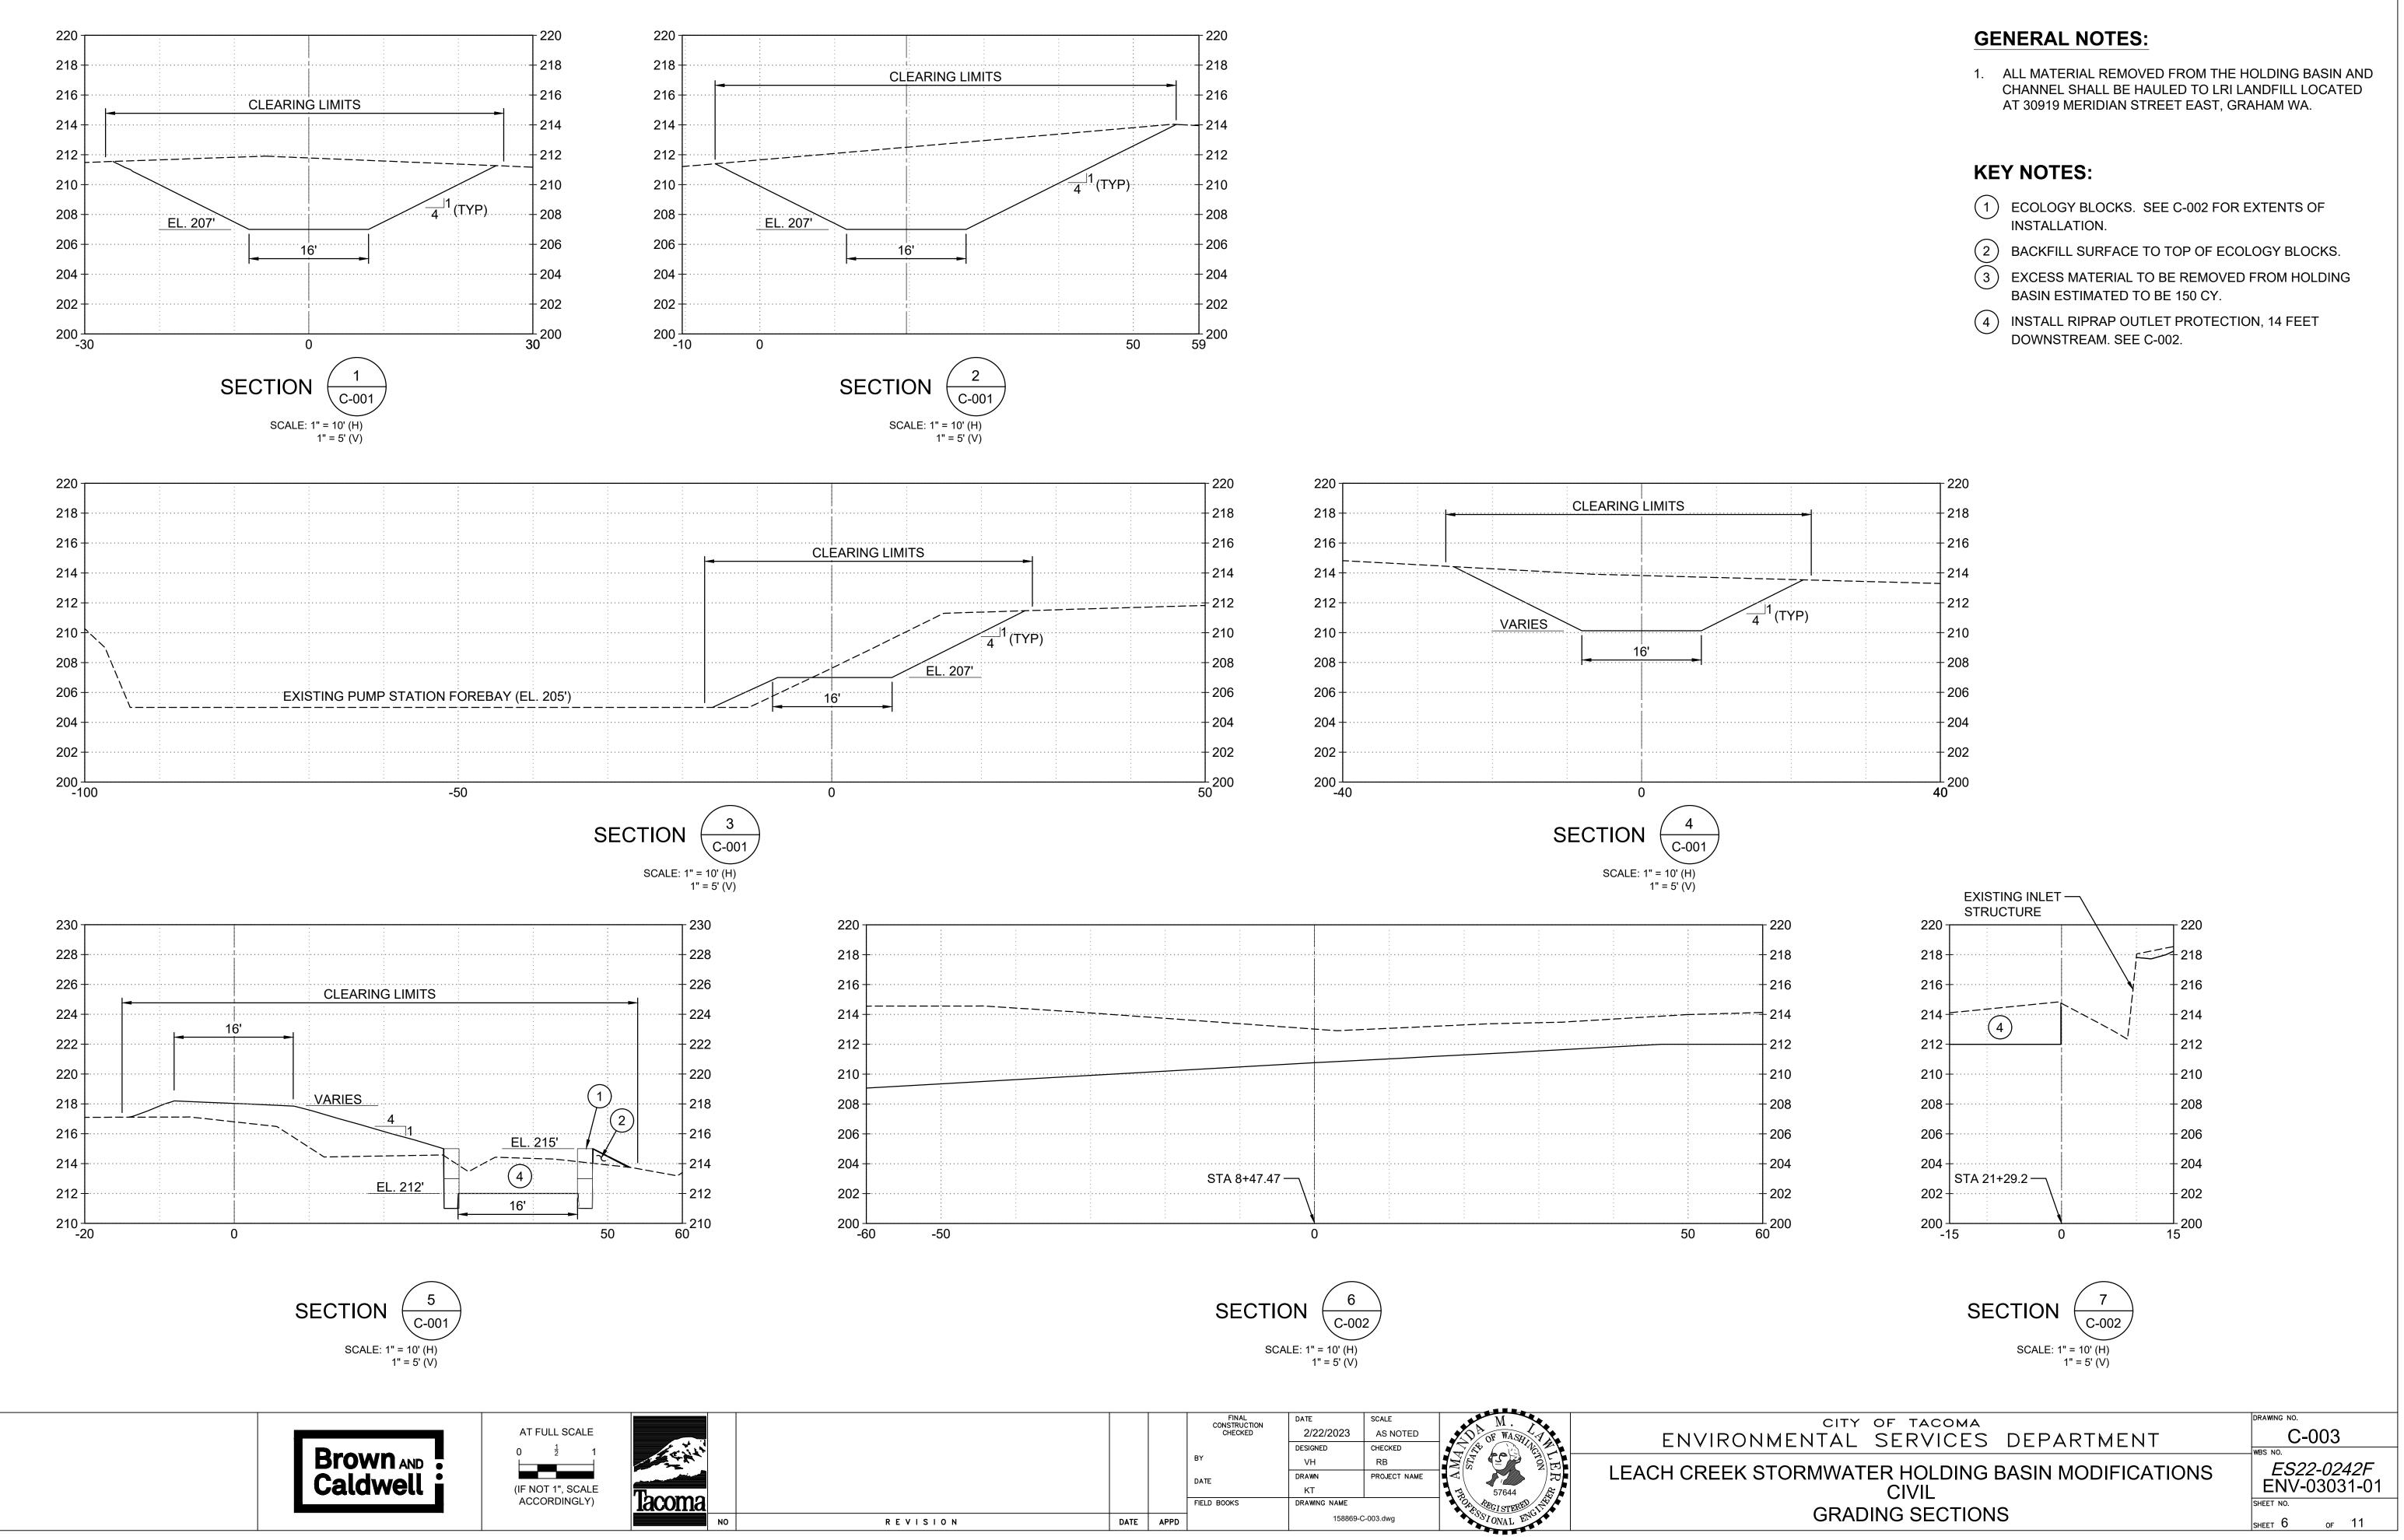

			CONSTRUCTION CHECKED	2/22/2023	AS NOTED	D OF WASE	
				DESIGNED	CHECKED		
			BY	VH	RB	NES SER	
			DATE	DRAWN	PROJECT NAME		LEACH CREEK
				КТ		57644	
			FIELD BOOKS	DRAWING NAME		CAR REGISTERED CITY	
REVISION	DATE	APPD		158869-0	C-003.dwg	"SIONAL ENG	

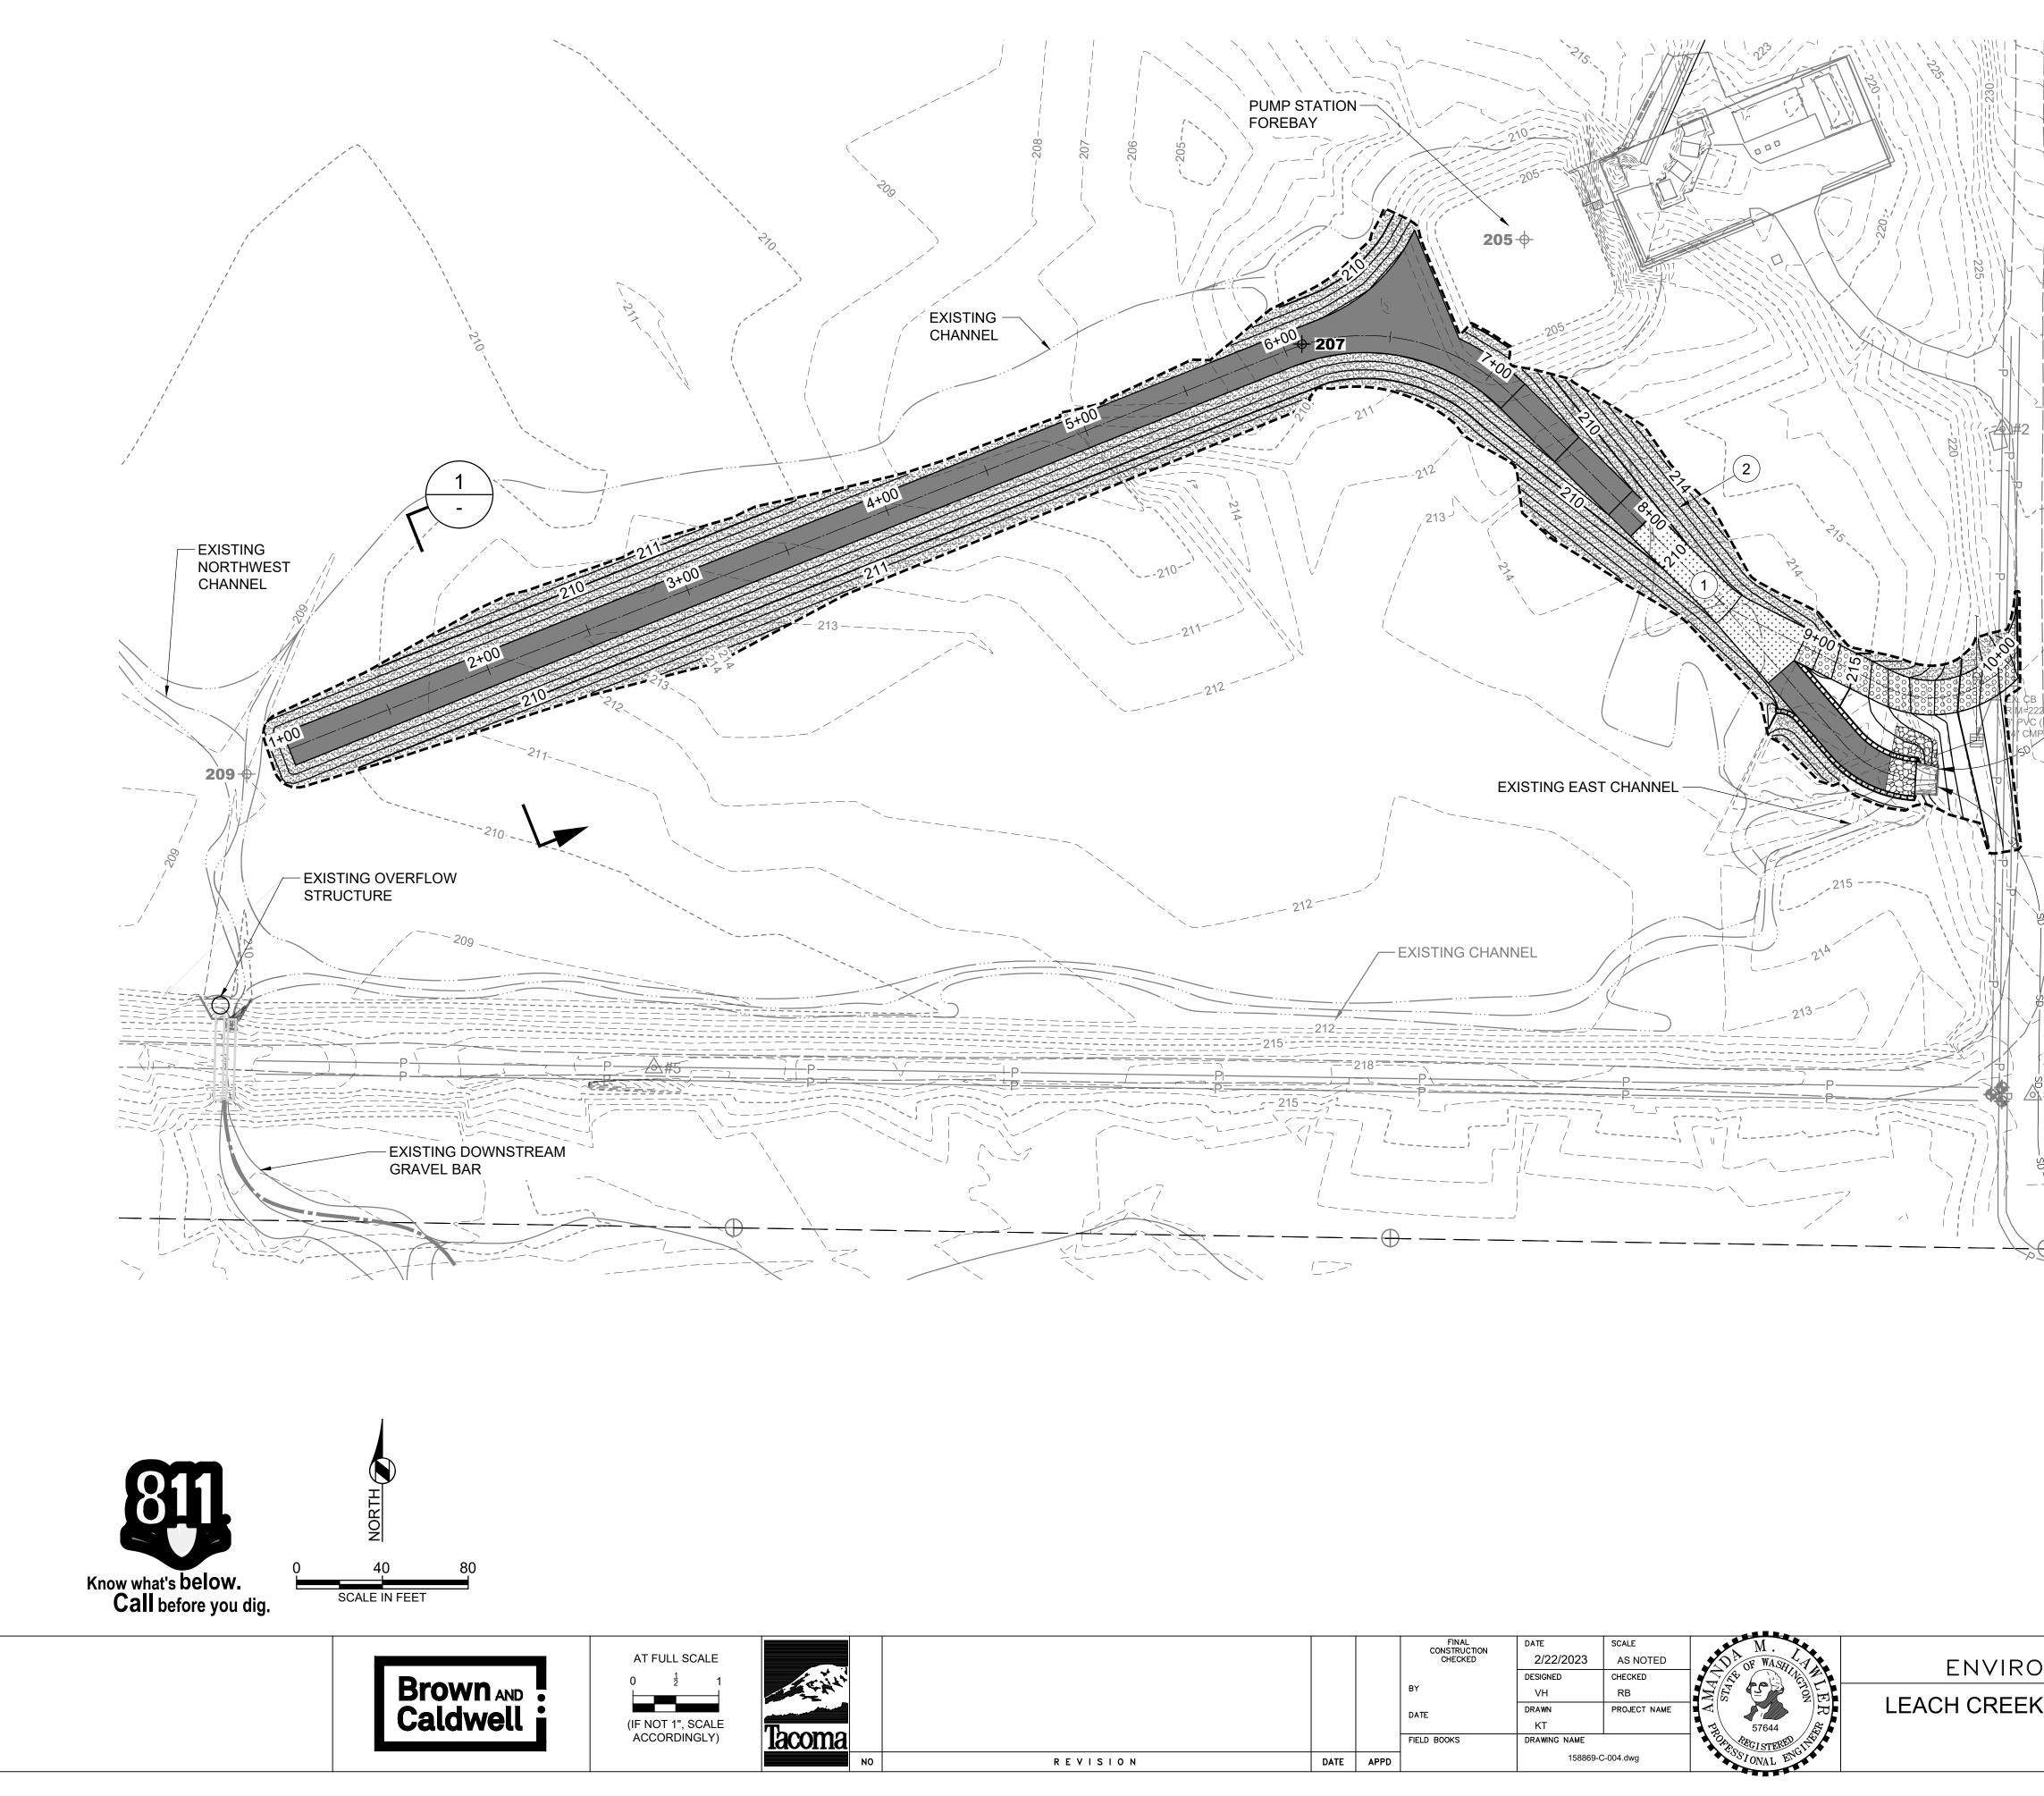

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			CHECKED	2/22/2023	AS NOTED	OF WASE	FNVIRON
				DESIGNED	CHECKED		
			BY	VH	RB	NES STREET	
			DATE	DRAWN	PROJECT NAME		LEACH CREEK S
				КТ		57644	
			FIELD BOOKS	DRAWING NAME		ARGISTERED STA	
REVISION	DATE	APPD		158869-0	C-004.dwg	USIONAL ENG	

GENERAL NOTES:

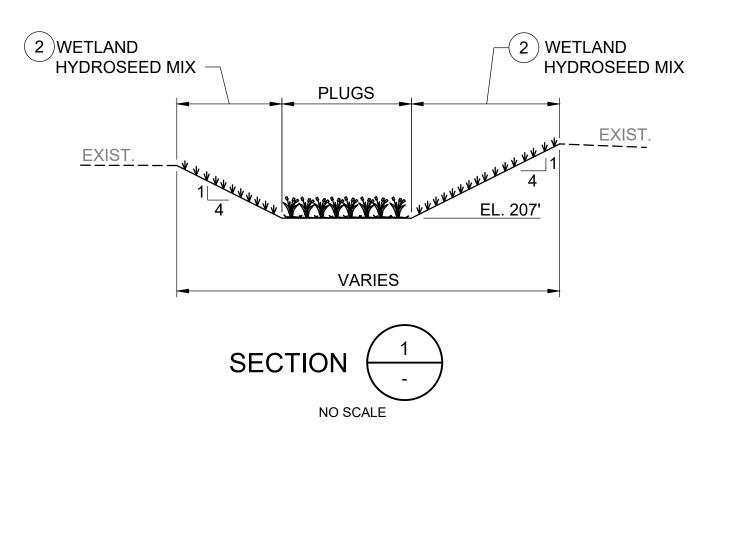
1. SOURCE OF SURVEY DATA IS PER CITY OF TACOMA. CONTRACTOR TO FIELD VERIFY ALL ELEVATIONS.

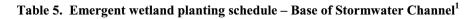
KEY NOTES:

219.81 IE 219.11



SEE SHEET C-005 FOR EROSION CONTROL BLANKET OVER WETLAND HYDROSEED INSTALLATION DETAILS. (2)





Common Name	Species Name	Indicator Status	Size	Spacing (O.C)
Emergent Species				
Slough sedge	Carex obnupta	OBL	Plug	2 ft.
Saw-beaked sedge	Carex stipata	OBL	Plug	2 ft.
Tall mannagrass	Glyceria elata	FACW	Plug	2 ft.
Tapertip rush	Juncus acuminatus	OBL	Plug	2 ft.
Hardstem bulrush	Schoenoplectus acutus	OBL	Plug	2 ft.
Small-flowered bulrush	Scirpus microcarpus	OBL	Plug	2 ft.
	1 1.1 0	1.		

¹ Quantities to be determined upon completion of grading. ² Plugs will be planted in clumps of four.


Table 6. Wetland hydroseed mix – Slopes of Stormwater Channel^{1, 2, 3}

	Common Name	Species Name	Indicator
			Status
	Tall mannagrass	Glyceria elata	FACW
ی می ایند. می ایند از میند مید ایند	Tufted hairgrass	Deschampsia spicata	FACW
	Water foxtail	Alopecurus geniculatus	FACW
	Meadow barley	Hordeum brachyantherum	FACW
	Slough sedge	Carex obnupta	OBL
	¹ An assortment (by weight	t) of the species listed in Table	6 should be include

cluded in the seed mix.

² Seed mix shall be applied at approximately 0.25-.50 lbs. per 1,000 sq. ft.
³Species may be substituted with other native wetland species if availability is limited.

CITY OF TACOMA	DRAWING NO.
NMENTAL SERVICES DEPARTMENT	C-004
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STORMWATER HOLDING BASIN MODIFICATIONS	ES22-0242F
	ENV-03031-01
CIVIL	SHEET NO.
PLANTING PLAN AND DETAILS	7 11
	SHEET I OF II

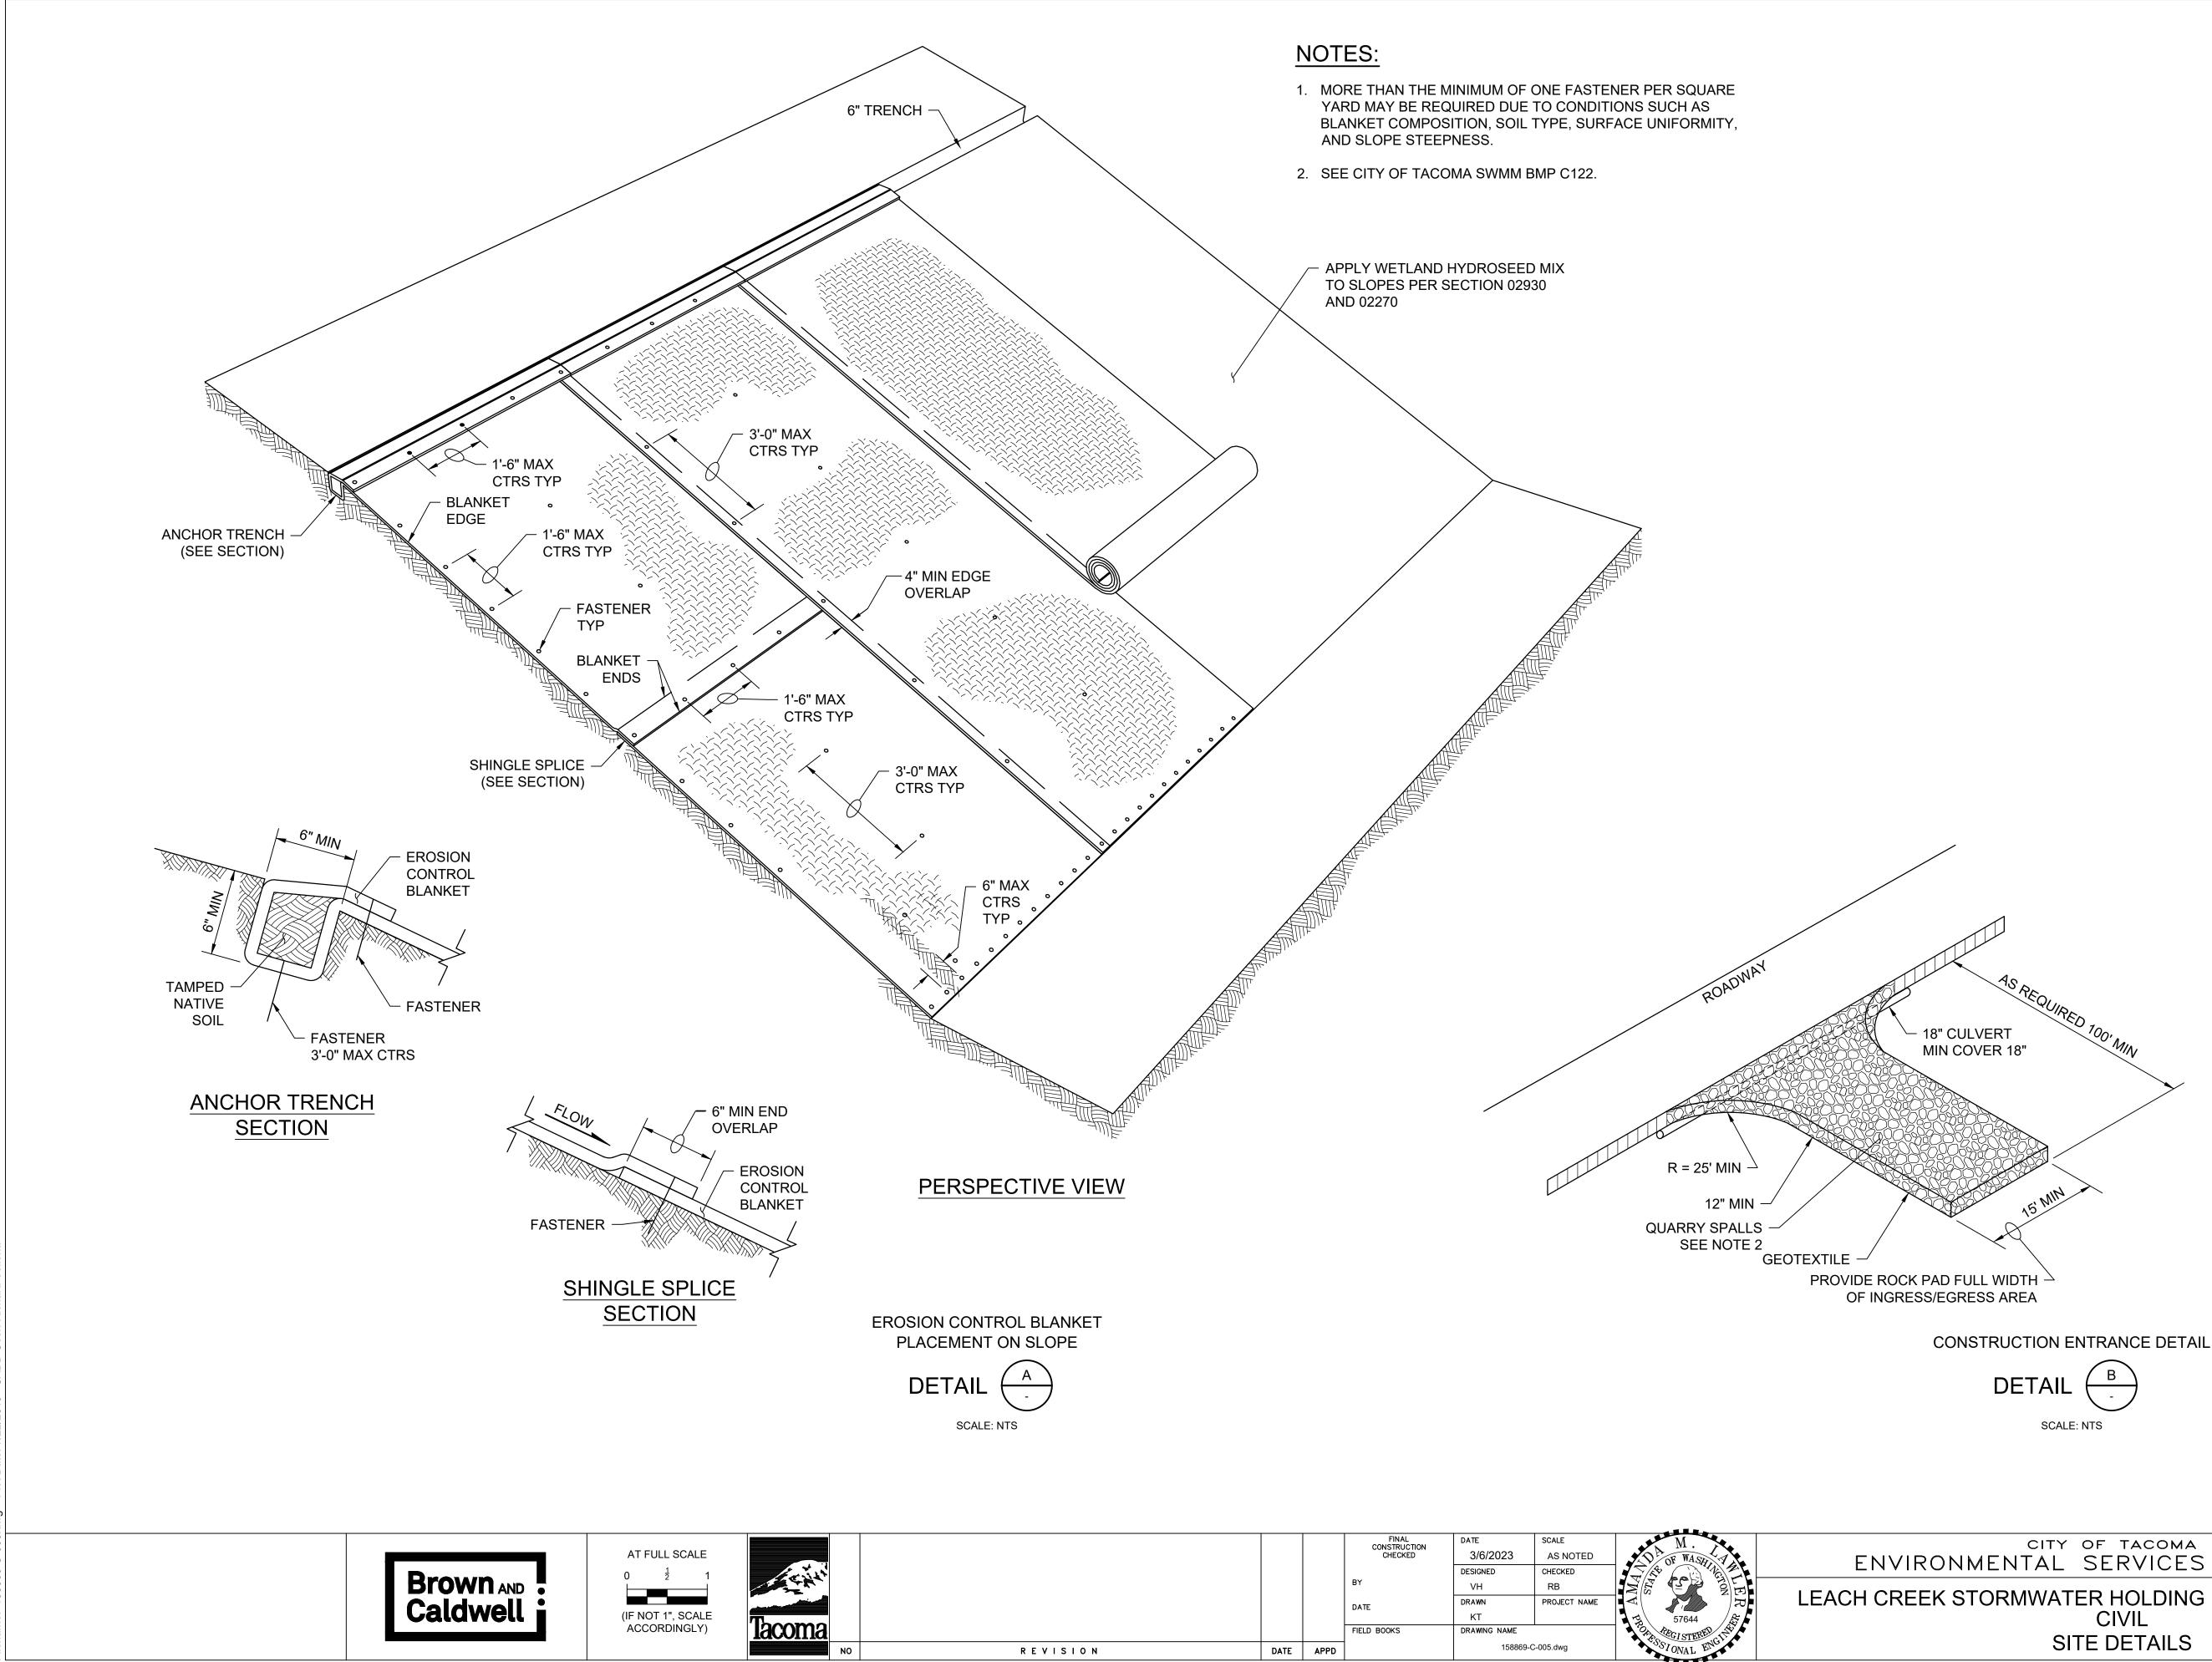

			FINAL CONSTRUCTION	DATE	SCALE	M.	
			CHECKED	3/6/2023	AS NOTED	DE WASK	FNVIRON
				DESIGNED	CHECKED		
			BY	VH	RB	NE SE	
			DATE	DRAWN	PROJECT NAME		LEACH CREEK S
				КТ		57644	
			FIELD BOOKS	DRAWING NAME		Property REGISTERED	
REVISION	DATE	APPD]	158869-0	C-005.dwg	OSTONAL ENG	

NOTES:

- 1. CONTRACTOR SHALL INSTALL AND MAINTAIN A STABILIZED CONSTRUCTION ENTRANCE WHERE VEHICLES ENTER THE PROJECT SITE.
- 2. THE ROCK PAD SHALL BE AT LEAST 12" THICK AND 100' LONG. MATERIAL SHALL BE 4" TO 8" QUARRY SPALLS AND MAY BE TOP-DRESSED WITH 1" TO 3" ROCK. WIDTH SHALL BE THE FULL WIDTH OF THE VEHICLE INGRESS AND EGRESS AREA.
- 3. ADDITIONAL ROCK SHALL BE ADDED PERIODICALLY TO MAINTAIN PROPER FUNCTION OF THE PAD.
- 4. CONTRACTOR TO MAINTAIN ROAD DURING CONSTRUCTION TO MINIMIZE TRACK-OUT OF DIRT AND MATERIAL.
- 5. CONSTRUCTION ENTRANCE SHALL MEET CITY OF TACOMA SWMM REQUIREMENTS.

CITY OF TACOMA	DRAWING NO.		
NMENTAL SERVICES DEPARTMENT	C-0)05	
	WBS NO.		·
STORMWATER HOLDING BASIN MODIFICATIONS	ES22		
CIVIL	ENV-C)303	1-01
	SHEET NO.		
SITE DETAILS	SHEET 8	OF	12

GENERAL STRUCTURAL NOTES

DESIGN CRITERIA

APPLICABLE BUILDING NOTES AND CODES

INTERNATIONAL BUILDING CODE, IBC 2018 EDITION, EXCEPT WHERE OTHER CODES ARE MORE RESTRICTIVE.

LIVE LOADS

PLATFORM GRATING .25 psf

DRILLED-IN CONCRETE ANCHOR (DICA)

DRILLED-IN EXPANSION BOLTS SHALL BE STAINLESS STEEL "KWIK BOLT TYPE TZ" BY HILTI CORP., OR APPROVED EQUAL. ICBO CERTIFICATION IS REQUIRED.

ADHESIVE ANCHORING SYSTEM SHALL BE STAINLESS STEEL RODS AISI 316. REINFORCING BARS AND RODS ANCHORED INTO EXISTING CONCRETE SHALL BE IN DRILLED HOLE WITH HILTI "HIT-RE 500 V3", OR SIKA "SIKADUR" EPOXY INJECTION GEL OR APPROVED EQUAL. ICBO CERTIFICATION AND SPECIAL INSPECTION IS REQUIRED.

CEMENT GROUT/MORTAR

GROUT AND FILL GROUT SHALL BE HIGH-STRENGTH, NON-SHRINK CEMENTITIOUS UNDERWATER CEMENT RESISTANT TO WASH-OUT.

SURFACE PREPARATION, MIXING, AGGREGATES, AND PLACEMENT SHALL CONFORM MANUFACTURE'S INSTRUCTIONS.

UNDERWATER GROUT SHALL BE AS MANUFACTURED BY DAYTON SUPERIOR, FIVE STAR, USCP CONCRETE PRODUCTS OR EUCLID CHEMICAL. SUBMIT PRODUCT CUTSHEET.

ALUMINUM MATERIAL

ALUMINUM CONSTRUCTION SHALL BE IN ACCORDANCE WITH ASCE SPECIFICATIONS FOR STRUCTURES OF ALUMINUM. MATERIAL TO BE ALLOY 6061-T6, UNLESS NOTED OTHERWISE.

ALL CONNECTIONS BOLTS FOR ALUMINUM SHALL BE STAINLESS STEEL. WHERE ALUMINUM IS IN CONTACT WITH STEEL, CONCRETE OR MASONRY SURFACES, CONTACT SURFACES SHALL BE COATED WITH HEAVY ALKALI-RESISTANT BITUMINOUS PAINT, OR COAL TAR EPOXY PROTECTING COAT.

WELDING

MATERIALS AND PROCEDURES FOR WELDING ALUMINUM SHALL BE IN ACCORDANCE WITH AWS D1.2 CODE.

STAINLESS STEEL

MATERIAL STAINLESS STEEL CONSTRUCTION SHALL BE IN ACCORDANCE WITH AISI SPECIFICATIONS. STRUCTURES OF STAINLESS STEEL SHALL CONFORM TO AISI TYPE 304 OR ASTM A240. STAINLESS STEEL BOLTS AND NUTS SHALL CONFORM TO ASTM A193 AND A194.

WELDING

MATERIALS AND PROCEDURES FOR WELDING STAINLESS STEEL SHALL BE IN ACCORDANCE WITH AWS D1.6 CODE.

SPECIAL INSPECTION

THE FOLLOWING ITEMS REQUIRE SPECIAL INSPECTION PER IBC SECTION 1704.

DRILLED IN CONCRETE ANCHORS:

PERIODIC SPECIAL INSPECTION SHALL INCLUDE VISUAL OBSERVATION OF DRILLED HOLE, SPACINGS, AND EDGE DISTANCES.

EPOXY OR CEMENT GROUTED DOWELS OR ANCHORS: OBSERVE DRILLED HOLES AFTER CLEANING AND OBSERVE INSTALATION OF GROUT ANCHORS.

MISCELLANEOUS

VERIFY ALL DIMENSIONS AND CONDITION STARTING WORK AND NOTIFY THE ENGI DISCREPANCIES.

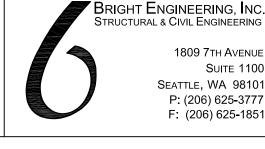
CALCULATIONS AND DRAWINGS FOR TH THAT ARE DESIGNED BY OTHER SHALL E STATE REGISTERED PROFESSIONAL ENG SHOP DRAWINGS TO THE ENGINEER FOR FABRICATION.

DEFERRED SUBMITTALS INCLUDE: PRECAST CONCRETE RISER AND ANC VALVE ANCHORAGE CALCULATIONS

SUBMIT ALL REQUIRED SHOP DRAWINGS REVIEW FROM THE ENGINEER, PRIOR TO


STRUCTURAL SYSTEM HAS BEEN DESIG COMPLETED STRUCTURE. PROVIDE TEM SHORING AS REQUIRED FOR STABILITY STRUCTURES, DURING ALL PHASES OF (

REFER TO SPECIFICATIONS FOR INFORM GENERAL NOTES.



1809 7TH AVENUE SUITE 1100 SEATTLE, WA 98101 P: (206) 625-3777 F: (206) 625-1851

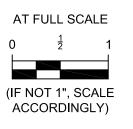
RUCTURAL & CIVIL ENGINEERING





	<u>ABBREVI</u>	ATIONS						
	@	AT			NTS	NOT TO SCALE	STD	STANDARD
IONS AT THE PROJECT SITE PRIOR TO	AB	ANCHOR BOLT	FT	FEET OR FOOT			STL	STEEL
GINEER IMMEDIATELY OF ANY	AL	ALUMINUM	GA	GAUGE, GAGE	OC	ON CENTER,	T&B	TOP AND BOTTOM
			GALV	GALVANIZED		CENTERS	TOC	TOP OF CONCRETE
	BOT	BOTTOM			OD	OUTSIDE DIAMETER	TOS	TOP OF STEEL
THE DESIGN AND FABRICATION OF ITEMS			ID	INSIDE DIAMETER	OPNG	OPENING	TOW	TOP OF WALL
L BE PREPARED BE A WASHINGTON	CL	CENTER LINE	IE	INVERT ELEVATION			TYP	TYPICAL
INGINEER. SUBMIT CALCULATIONS AND	CLR	CLEAR	IF	INSIDE FACE	PL	PROPERTY LINE		
OR SATISFACTORY REVIEW PRIOR TO	CONC	CONCRETE	IN	INCH		OR PLATE	UNO	UNLESS NOTED
	CONN	CONNECTION			PSF	POUNDS PER SQUARE	OTHERWISE	
	CONT	CONTINUOUS	KSI	KIPS PER SQUARE	FOOT			
			INCH		PSI	POUNDS PER SQUARE	VERT	VERTICAL
NCHORAGE CALCULATIONS	DIA	DIAMETER			INCH			
S	DICA	DRILLED IN	L	LENGTH OR ANGLE			w/	WITH
		CONCRETE ANCHOR	LB	POUND	R	RADIUS	w/o	WITHOUT
GS AND RECEIVE THEIR SATISFACTORY	DWG	DRAWING	LONGIT	LONGITUDINAL	REBAR	REINFORCEMENT BAR		
TO FABRICATION.					REINF	REINFORCEMENT OR		
	EA	EACH	MAX	MAXIMUM		REINFORCING		
IGNED FOR OPERATIONAL LOADS ON THE	EF	EACH FACE	MECH	MECHANICAL	REQD	REQUIRED		
EMPORARY ERECTION BRACING AND	EL	ELEVATION	MIN	MINIMUM				
Y OF THE STRUCTURE AND ADJACENT	ELEC	ELECTRICAL	MISC	MISCELLANEOUS	SECT	SECTION		
F CONSTRUCTION.	ES	EACH SIDE			SHT	SHEET		
	EW	EACH WAY	N/A	NOT APPLICABLE	SIM	SIMILAR		
RMATION NOT CONTAINED IN THESE	EXIST	EXISTING	NF	NEAR FACE	SPCG	SPACING		
	EXP	EXPANSION	NO	NUMBER	SS	STAINLESS STEEL		

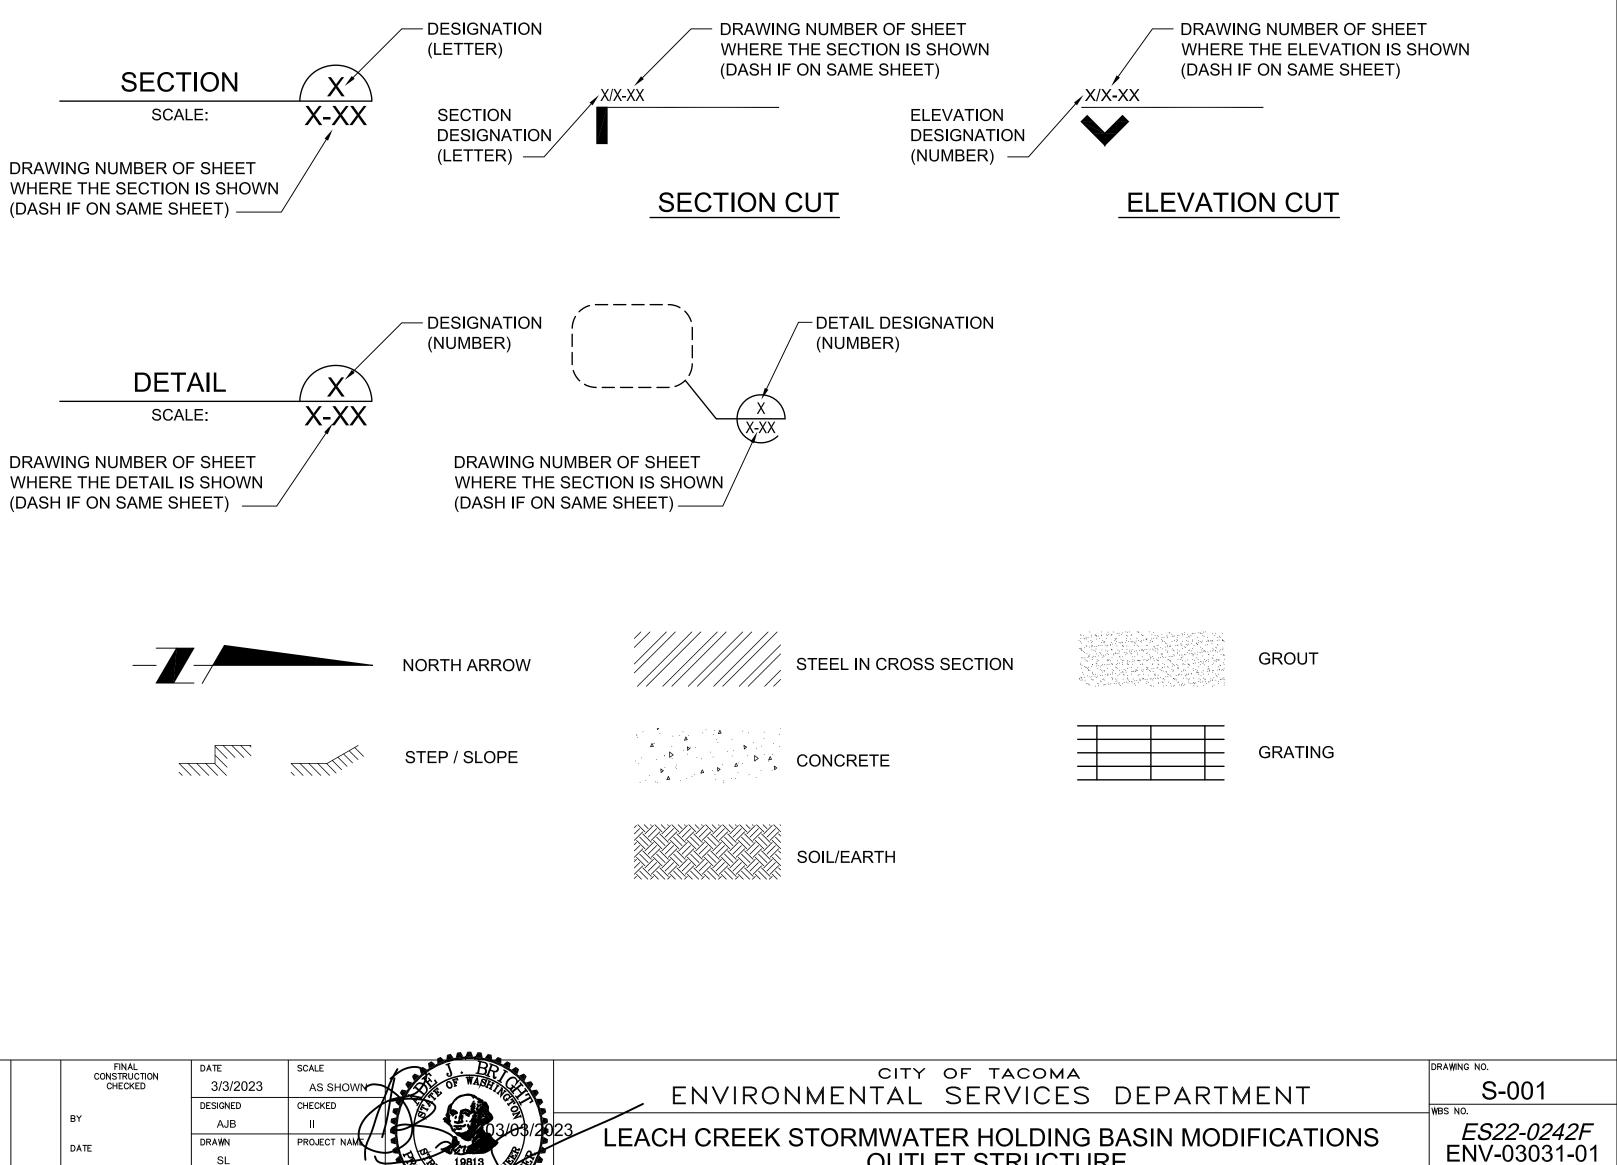LEGEND




			FINAL CONSTRUCTION CHECKED	DATE 3/3/2023	SCALE AS SHOWN	ST WART	
				DESIGNED	CHECKED		ENVIRON
			BY	AJB	<u> </u>	03/03/20	²³ I FACH CREFK S
			DATE	DRAWN	PROJECT NAME	And And	LEACH CREEK S
			FIELD BOOKS	SL DRAWING NAME	· · · ·	19813 19813	
REVISION	DATE	APPD		S-0	01.dwg	NONAL EN	GENERAL STRU
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OUTLET STRUCTURE	
UCTURAL NOTES, ABBREVIATIONS, AND LEGEND	

SHEET NO.

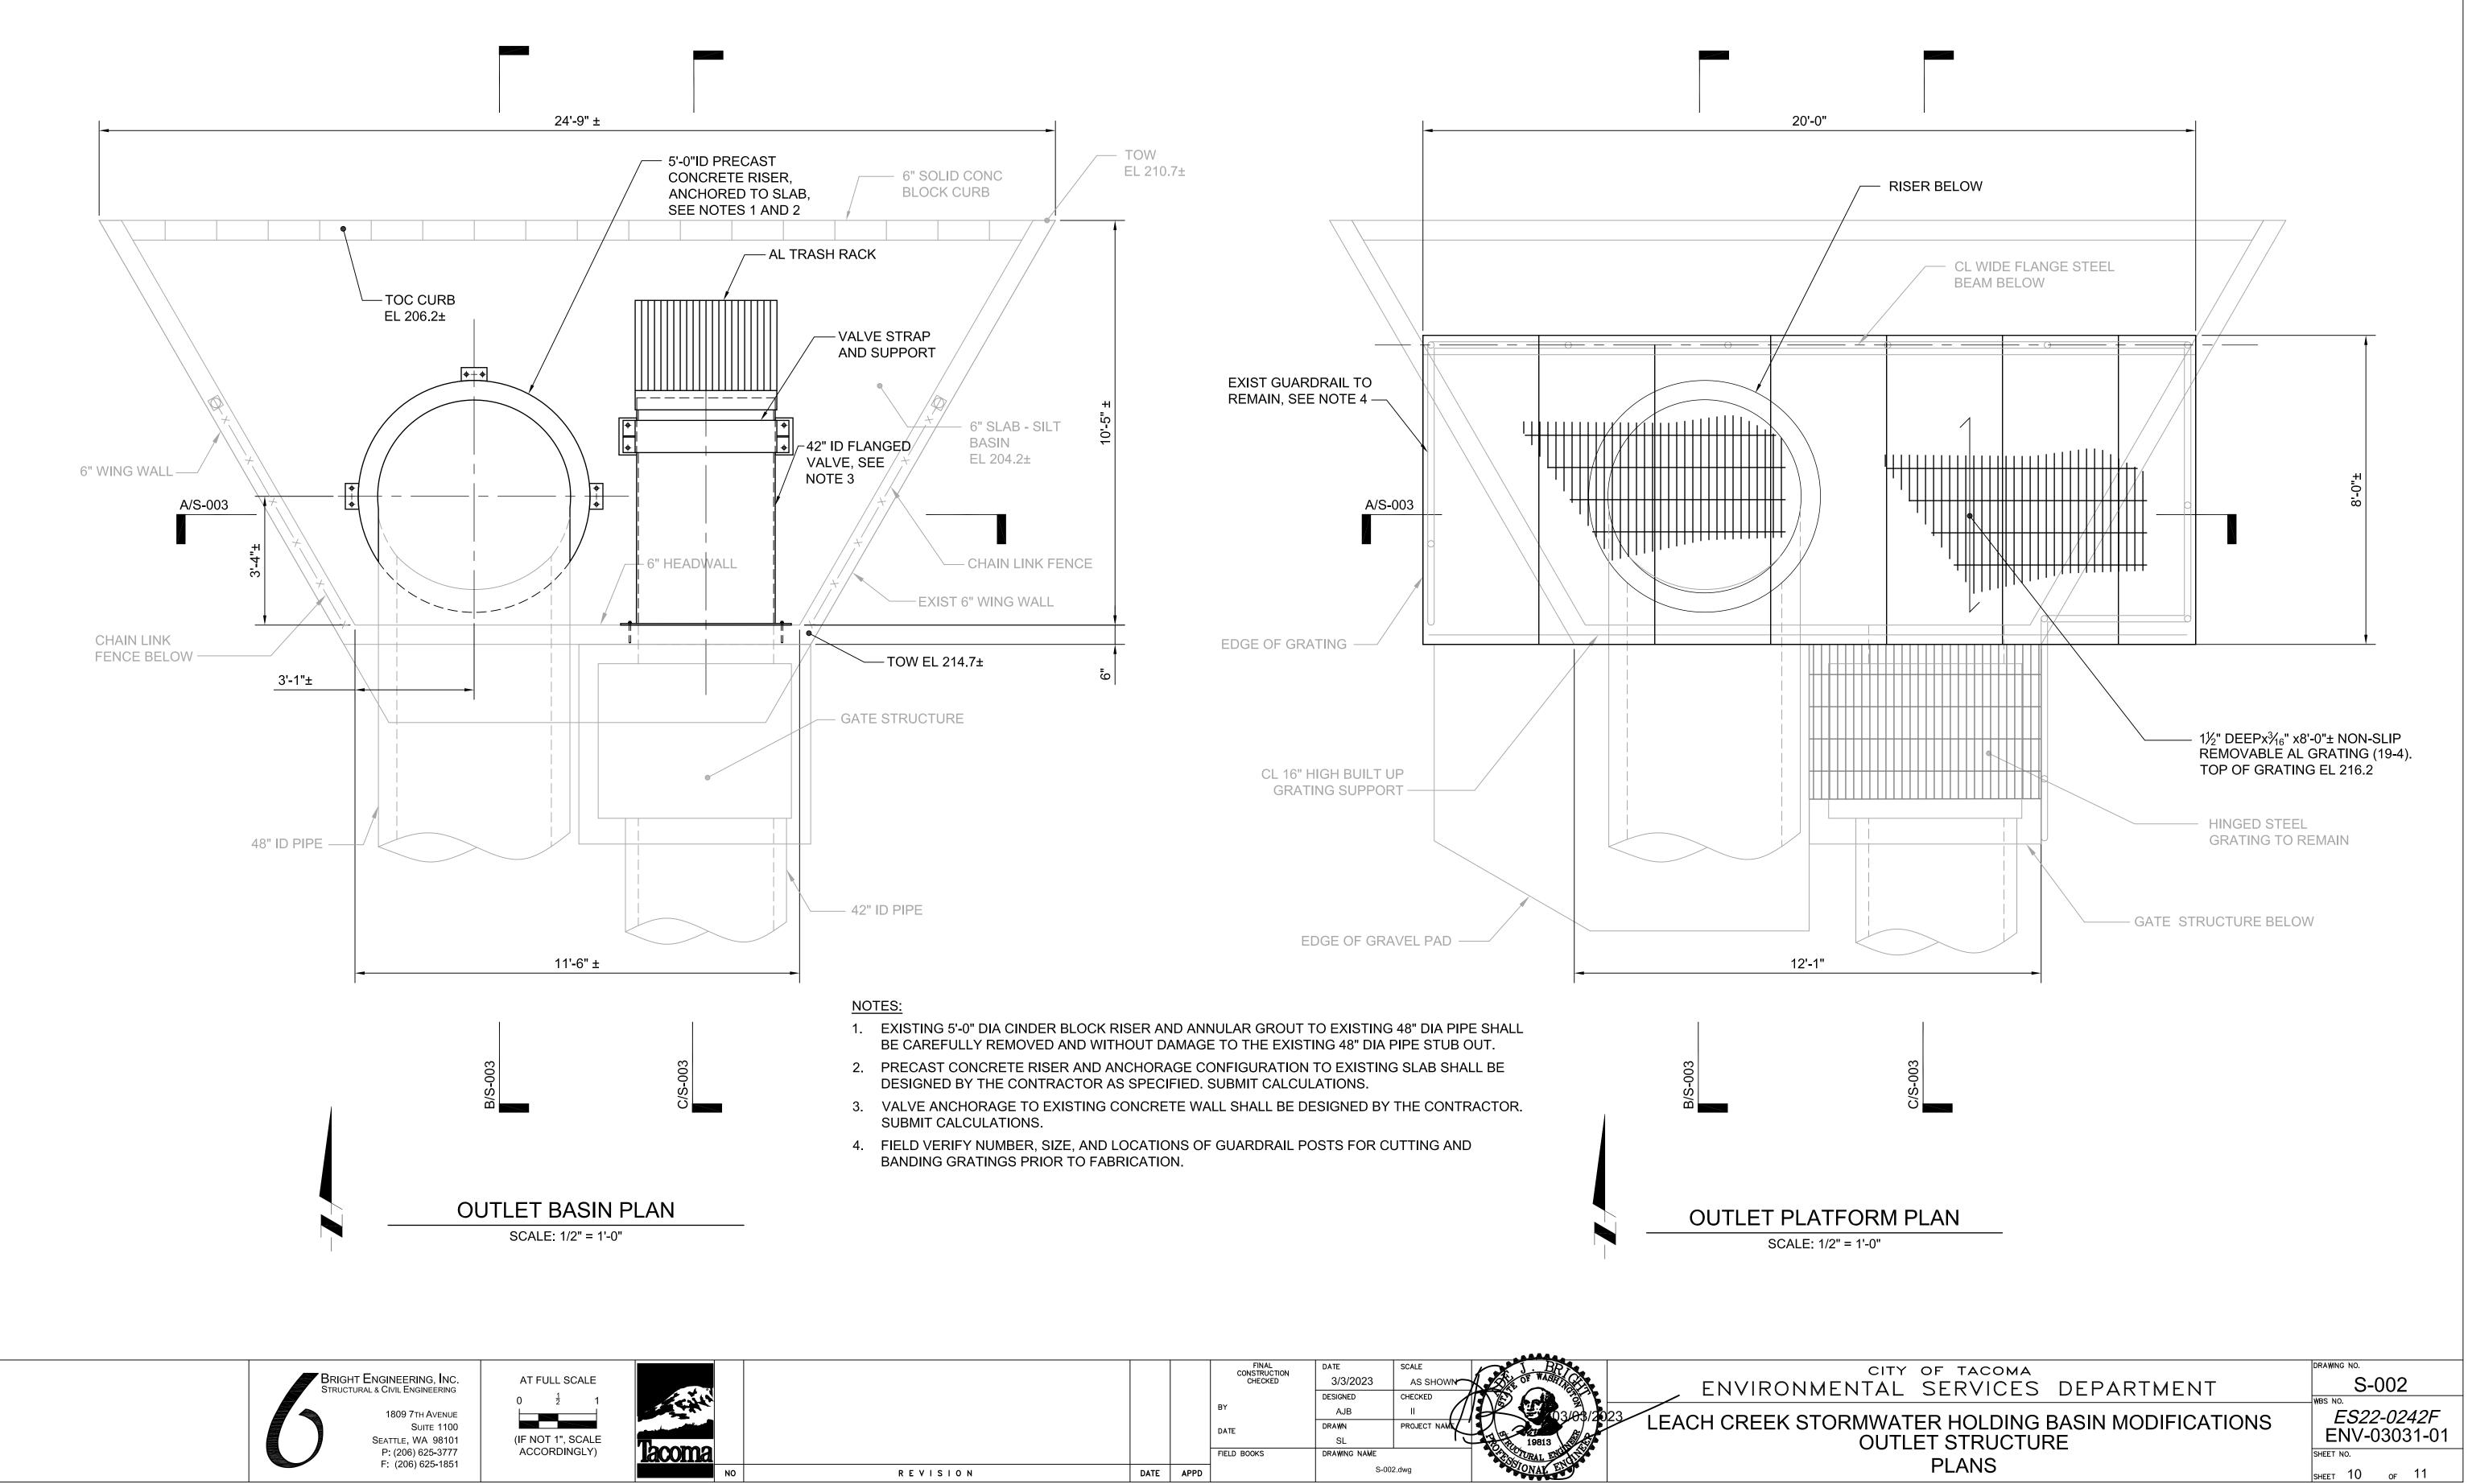sheet 9 of 11



			FINAL CONSTRUCTION CHECKED	DATE 3/3/2023	SCALE AS SHOWN	BR BR	
			ONEORED	DESIGNED	CHECKED		ENVIRON
			BY	AJB	н ()	03/03/20	
			DATE		PROJECT NAME	19813	
			FIELD BOOKS	SL DRAWING NAME		19813 Internal English	
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