

Public Works Engineering Division

ADDENDUM NO. 2 DATE: 3-8-2024

REVISIONS TO: Request for Bids Specification No. PW23-0090F TPU S 17th St Court D/E

NOTICE TO ALL BIDDERS:

This addendum is issued to clarify, revise, add to or delete from, the original specification documents for the above project. This addendum, as integrated with the original specification documents, shall form the specification documents. The noted revisions shall take precedence over previously issued specification documents and shall become part of this contract.

REVISIONS TO THE SUBMITTAL DEADLINE:

The submittal deadline remains the same.

REVISIONS TO THE PLANS:

Revision #1

Replace the following project plan sheets with the attached plan sheets including Addendum #2 revisions (4 pages/plan sheets):

- 1. Sheet No. 7 / Sheet DTL-4 of DTL-4
- 2. Sheet No. 8 / Sheet D-1 of D-1
- 3. Sheet No. 10 / Sheet C-2 of C-2
- 4. Sheet No. 12 / Sheet PW-1 of PW-1

REVISIONS TO THE SPECIFICATIONS:


Revision #1

Replace contract specification section 2-03 with the attached specification section 2-03 (2 pages) noted as a part of this Addendum #2.

Revision #2

Replace contract specification section 8-40 with the attached specification section 8-40 (4 pages) noted as a part of this Addendum #2.

Form No. SPEC-220A Revised: 07/08/2022

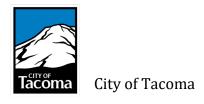

REVISIONS TO THE PROPOSAL PAGES:


Revision #1


Replace bid proposal in the bid submittal and specifications with the attached bid proposal with Addendum #2 noted at the top of each new bid proposal page. (10 pages)

NOTE: Acknowledge receipt of this addendum by initialing the corresponding space as indicated on the signature page. Vendors who have already submitted their bid/proposal may contact the Purchasing Division at 253-502-8468 and request return of their bid/proposal for acknowledgment and re-submittal. Or, a letter acknowledging receipt of this addendum may be submitted in an envelope marked Request for Bids Specification No. PW23-0090F Addendum No. 2. The City reserves the right to reject any and all bids, including, in certain circumstances, for failure to appropriately acknowledge this addendum.

cc: Basel Kitmitto, Public Works Engineering


Form No. SPEC-220A Revised: 07/08/2022

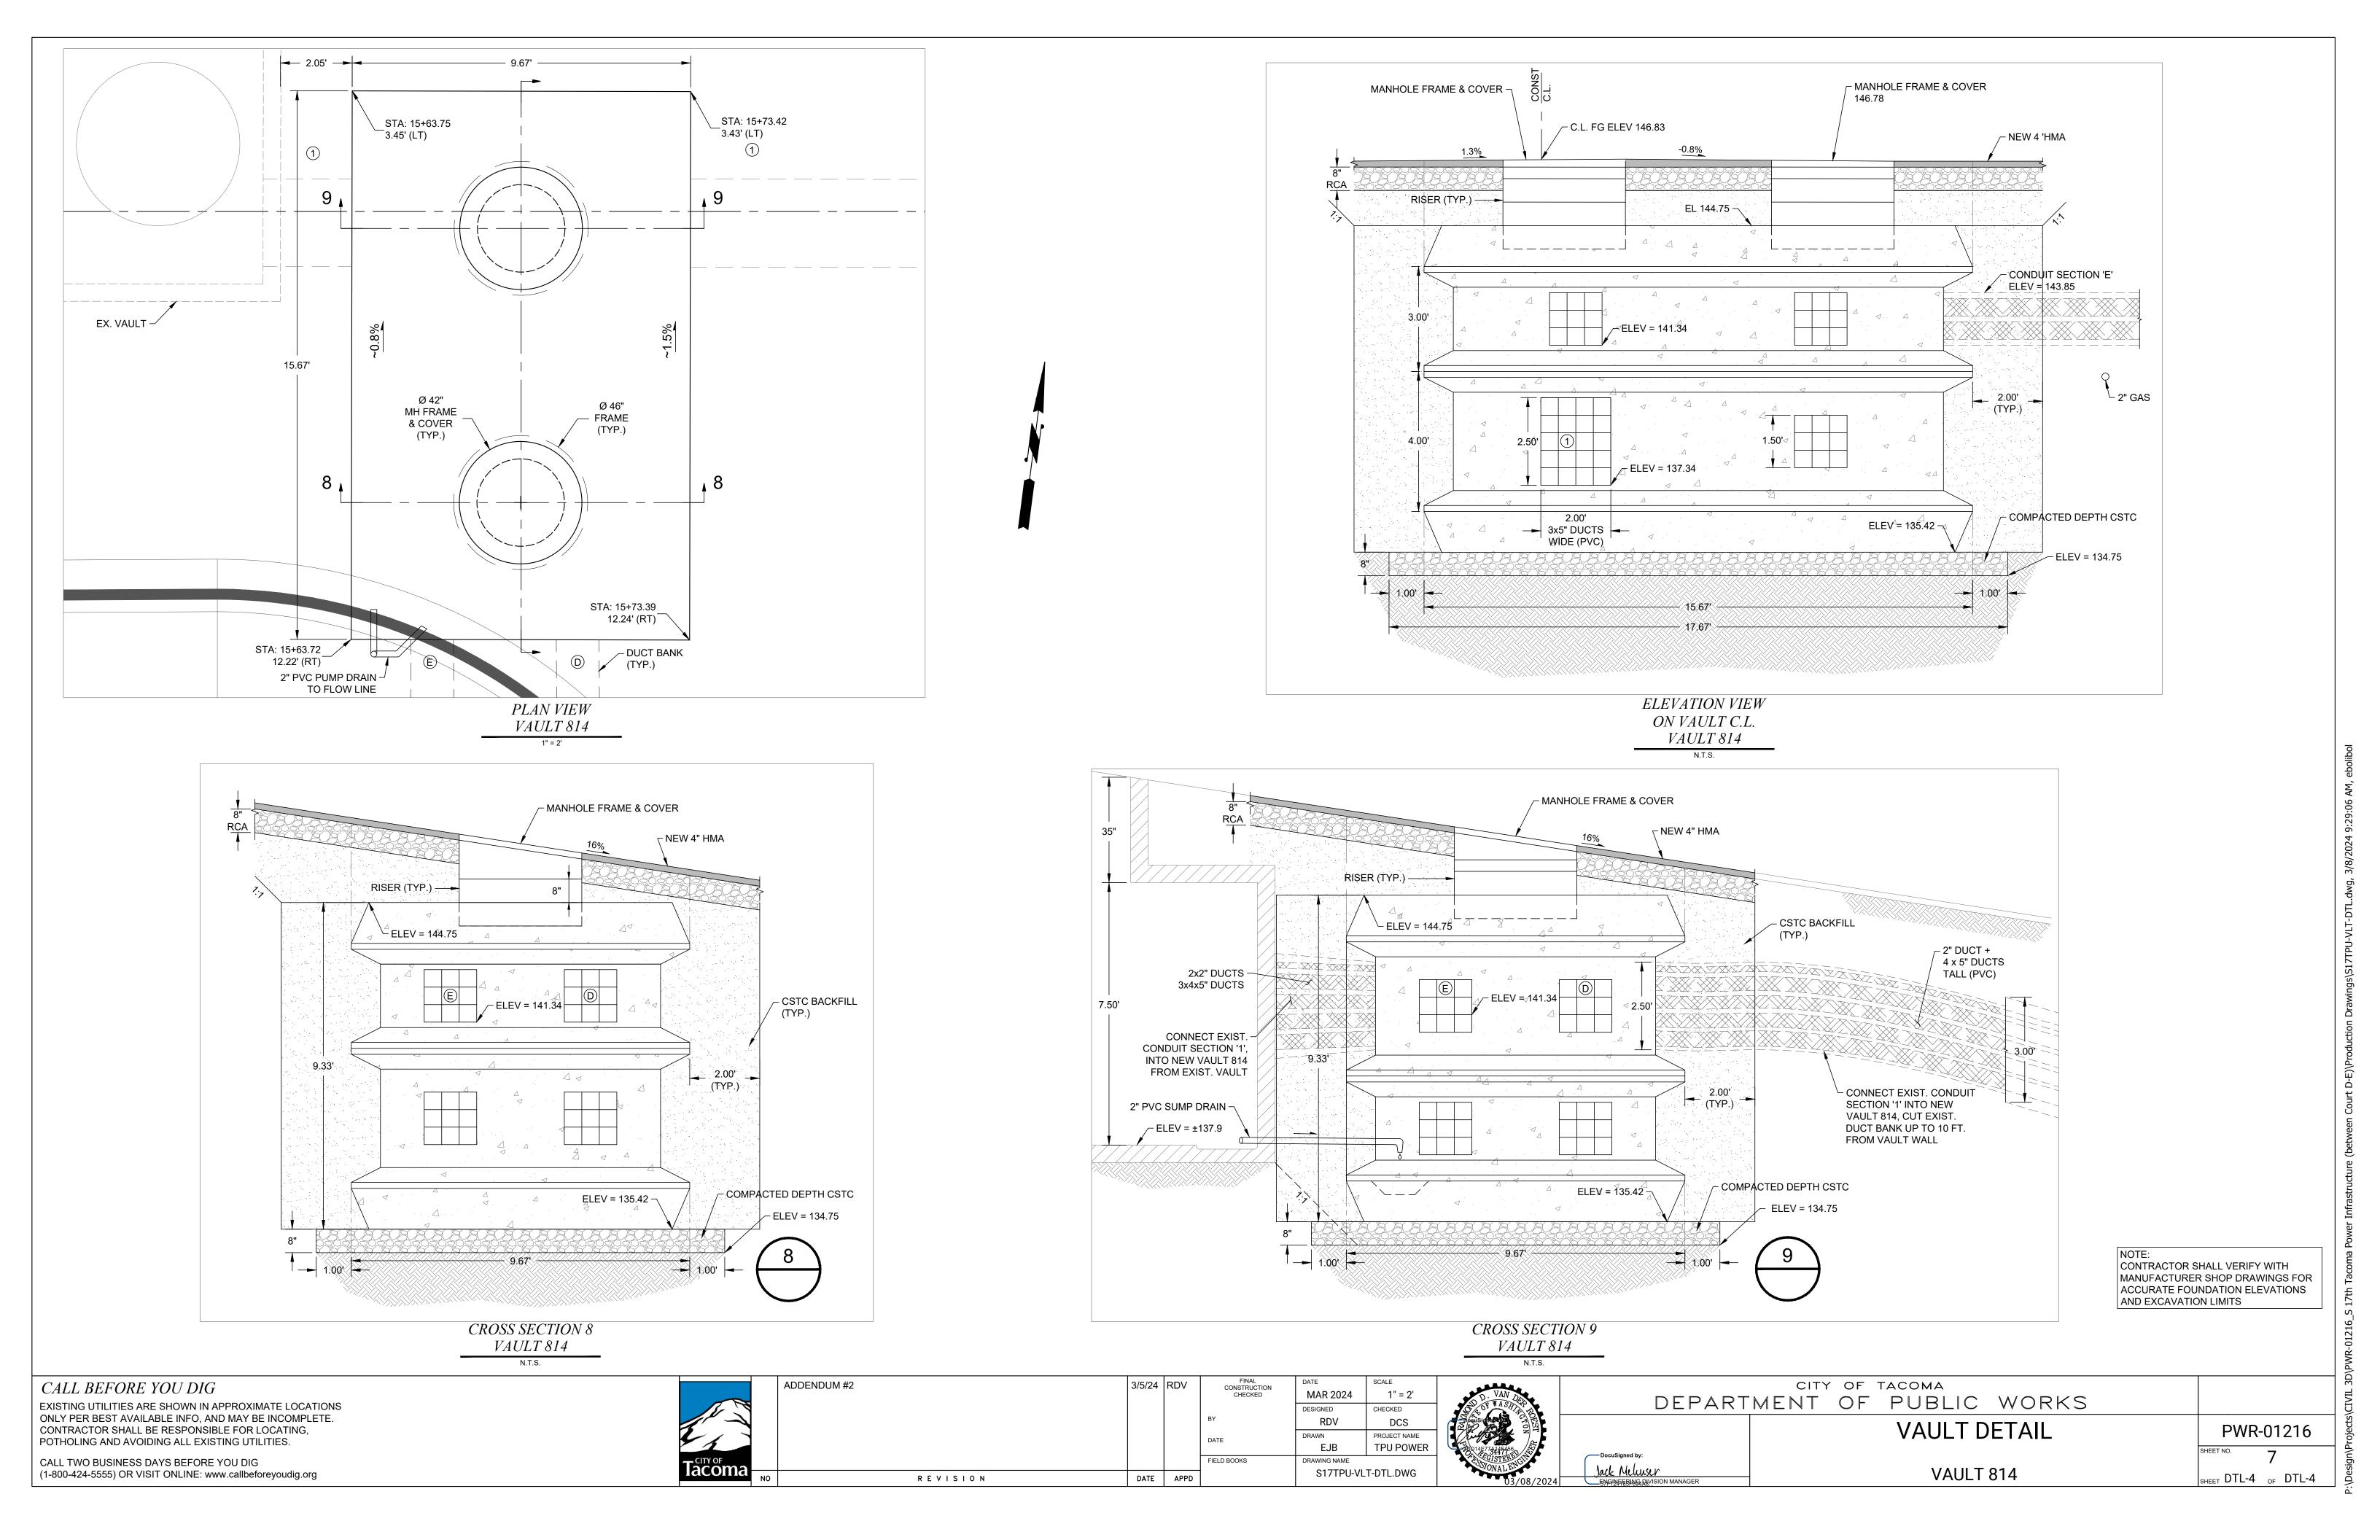

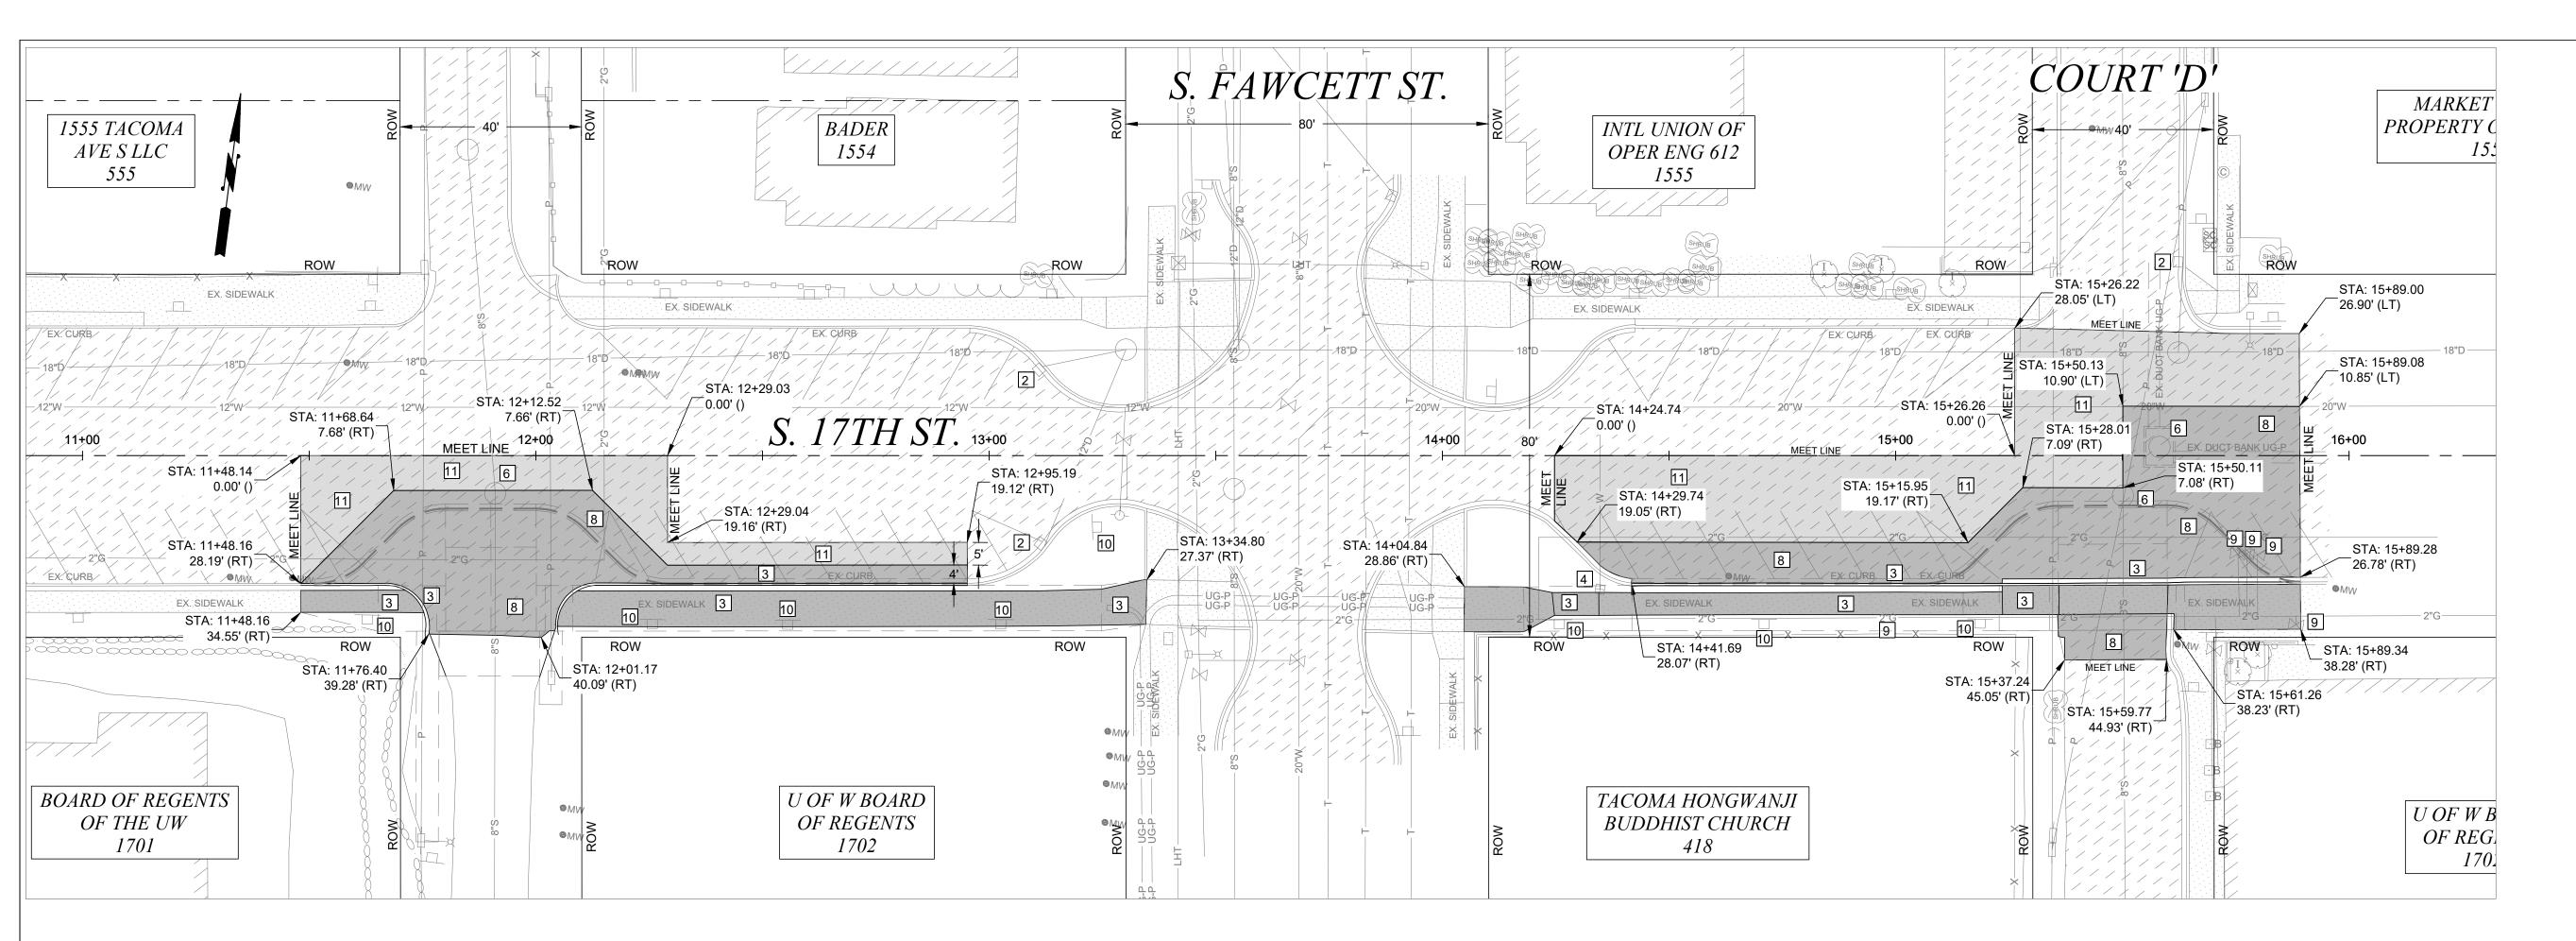

DEMOLITION NOTES

- 1 REMOVE EXISTING SURVEY MONUMENT IN ACCORDANCE WITH WAC 332-120, SUBMIT DEPARTMENT OF NATURAL RESOURCES APPLICATION FOR PERMIT TO REMOVE OR DESTROY A SURVEY MONUMENT. REMOVE EXISTING MONUMENT COMPLETELY TO INSURE SUITABLE INSTALLATION OF NEW GALVANIZED STEEL PIPE TO MINIMUM DEPTHS PER WDOT STD PLAN A-10.30-00.
- PROVIDE INLET PROTECTION TO EXISTING CATCH BASII
 PER SPECIFICATION 8-01 UNTIL REMOVAL OR END OF
 CONSTRUCTION ACTIVITIES
- 3 TO BE REMOVED
- 4 TO BE ADJUSTED BY OTHERS
- 5 TO BE RELOCATED BY OTHERS
- 6 ADJUST TO GRADE PER SPECIFICATION 7-05
- 7 ADJUST EXISTING VALVE PER CITY OF TACOMA STANDARD SU-37
- 8 REMOVE PAVEMENT PER SPECIFICATION 2-14
- 9 TO BE REMOVED BY PUGET SOUND ENERGY (PSE)
- REMOVE AND SALVAGE SIGN AND POST, TO BE RELOCATED PER PLANS AND AS DIRECTED BY ENGINEER
- 11 2" ASPHALT GRIND

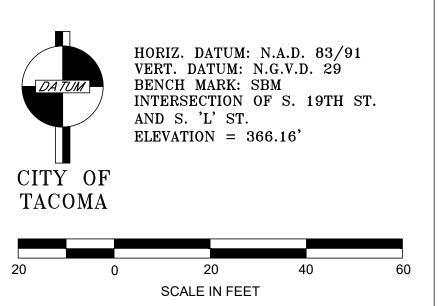

CALL BEFORE YOU DIG

EXISTING UTILITIES ARE SHOWN IN APPROXIMATE LOCATIONS ONLY PER BEST AVAILABLE INFO, AND MAY BE INCOMPLETE. CONTRACTOR SHALL BE RESPONSIBLE FOR LOCATING, POTHOLING AND AVOIDING ALL EXISTING LITHITIES.

ONTRACTOR SHALL BE RESPONSIBLE FOR LOCATING, OTHOLING AND AVOIDING ALL EXISTING UTILITIES.	
ALL TWO BUSINESS DAYS BEFORE YOU DIG -800-424-5555) OR VISIT ONLINE: www.callbeforeyoudig.org	

TE:
Tacoma

ADDENDUM #2	3/5/24	RDV	FINAL CONSTRUCTION	DATE	SCALE
			CHECKED	MAR 2024	1" = 20'
				DESIGNED	CHECKED
			BY	RDV	DCS
			DATE	DRAWN	PROJECT NAME
			BATE	EJB	TPU POWER
			FIELD BOOKS	DRAWING NAME	
REVISION	DATE	APPD		S17TPU	-D.DWG

	D. VAN DE
	NO TO NO
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	OSTONAL ENGINEER US / 08/2024

DocuSigned by:

Jak Muusur 5761 ENRINGERING DIVISION MANAGER

DEPART	MENT	OF	PUBLIC	WORKS
			DEMOLITIO	N PLAN


CITY OF TACOMA

S. 17TH TACOMA POWER INFRASTRUCTURE CT. D & E S. 17TH ST. FROM COURT D & E


PWR-01216

SHEET NO. 8

HEET D-1 OF D-1

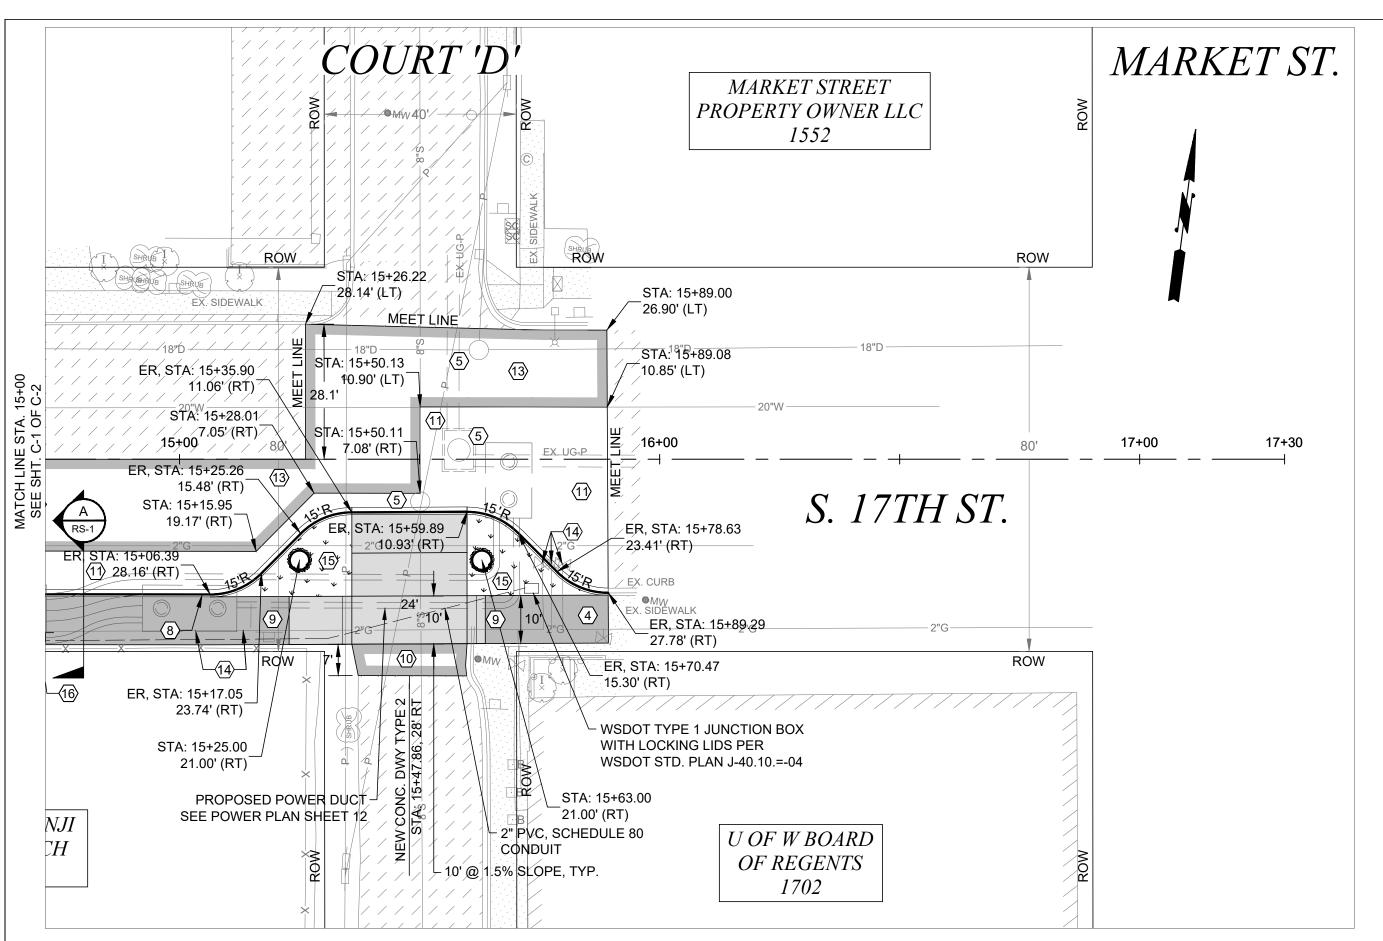


PROPOSED PLANTING SCHEDULE							
SYMBOL	SCIENTIFIC NAME	COMMON NAME					
REPLACEMENT TREE							
	ULMUS JAPONICA X WILSONIANA 'ACCOLADE'	ACCOLADE ELM					
	EUCOMMIA ULMOIDES	HARDY RUBBER TREE					
	CLADASTRIS KENTUKEA	AMERICAN YELLOWWOOD					

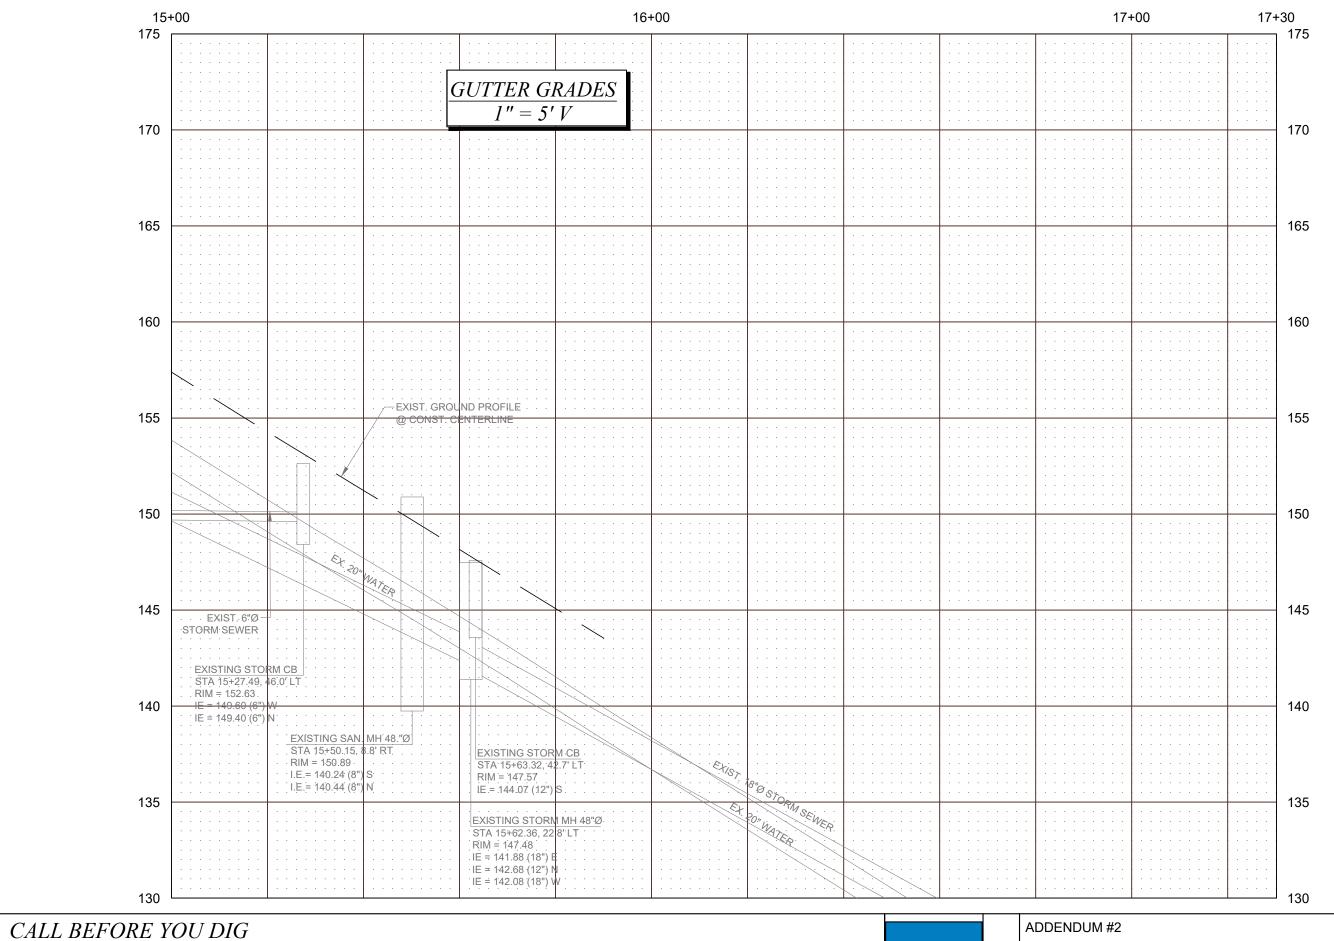

CONSTRUCTION NOTES

- (1) CONSTRUCT BRASS POURED MONUMENT PER CITY OF TACOMA STANDARD PLAN SU-01
- $|\langle \overline{\jmath}
 angle$ PROVIDE INLET PROTECTION TO PROPOSED CATCH BASIN |PER SPECIFICATION 8-01 UNTIL END OF CONSTRUCTION **ACTIVITIES**
- $|\langle 3 \rangle|$ TO BE ADJUSTED BY OTHERS
- $\langle 4 \rangle$ TO BE RELOCATED BY OTHERS
- $\langle 5 \rangle$ ADJUST TO GRADE PER SPECIFICATION 7-05
- 6 ADJUST EXISTING VALVE PER CITY OF TACOMA STANDARD SU-37
- (7) CONSTRUCT CEMENT CONCRETE CURB RAMP PER CITY OF TACOMA STANDARD PLAN SU-05 SERIES
- (8) CONSTRUCT CEMENT CONCRETE TRAFFIC CURB AND GUTTER PER CITY OF TACOMA STANDARD PLAN SU-03
- (9) CONSTRUCT CEMENT CONCRETE SIDEWALK PER CITY OF
- TACOMA STANDARD PLAN SU-04 (10) GRADE FOR POSITIVE DRAINAGE AND PLACE 2 INCH HMA CL ½ INCH PG 58H-22 OVER 2 INCH CRUSHED SURFACING
- TOP COURSE (11) CONSTRUCT HMA CL.1/2" PG 58H-22 PAVEMENT PER CITY OF TACOMA STANDARD PLAN SU-15A.
- REFER TO CROSS SECTION FOR MATERIAL AND DEPTHS. (12) GRADE FOR POSITIVE DRAINAGE AND PLACE 2 INCH CRUSHED SURFACING TOP COURSE
- 13 PLACE 2" HMA OVERLAY PER SECTION 5-04
- (14) TO BE REMOVED BY PUGET SOUND ENERGY (PSE)
- TS PLACE TOPSOIL TYPE A AND SEED GRASS IN ACCORDANCE WITH SECTION 8-02 AND STANDARD PLAN GSI-01D
- 1 RELOCATE SIGN PER PLANS OR AS DIRECTED BY THE **ENGINEER**

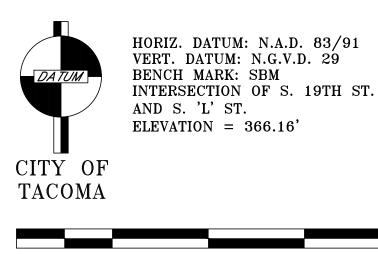

SCALE IN FEET

EXISTING UTILITIES ARE SHOWN IN APPROXIMATE LOCATIONS ONLY PER BEST AVAILABLE INFO, AND MAY BE INCOMPLETE. CONTRACTOR SHALL BE RESPONSIBLE FOR LOCATING, POTHOLING AND AVOIDING ALL EXISTING UTILITIES.

CALL TWO BUSINESS DAYS BEFORE YOU DIG (1-800-424-5555) OR VISIT ONLINE: www.callbeforeyoudig.org

50W #2	0/0/24	ND V	CHECKED	MAR 2024	1" = 20'
				DESIGNED	CHECKED
			BY	RDV	DCS
			DATE	DRAWN	PROJECT NAME
			BATE	EJB	TPU POWER
			FIELD BOOKS	DRAWING NAME	
REVISION	DATE	APPD		S17TPU	⊦C.DWG

3/5/24 RDV

FINAL CONSTRUCTION

03/08/2024 Jack Meluser


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Foresigned by ST	
TO A BY TO SHAPE TO SEE	

CITY	OF	TACOMA	
DEPARTMENT	OF	PUBLIC	WORKS

CONSTRUCTION PLAN & PROFILE S. 17TH TACOMA POWER INFRASTRUCTURE CT. D & E

S. 17TH ST. FROM COURT D & E

PWR-01216 HEET C-2 OF C-2

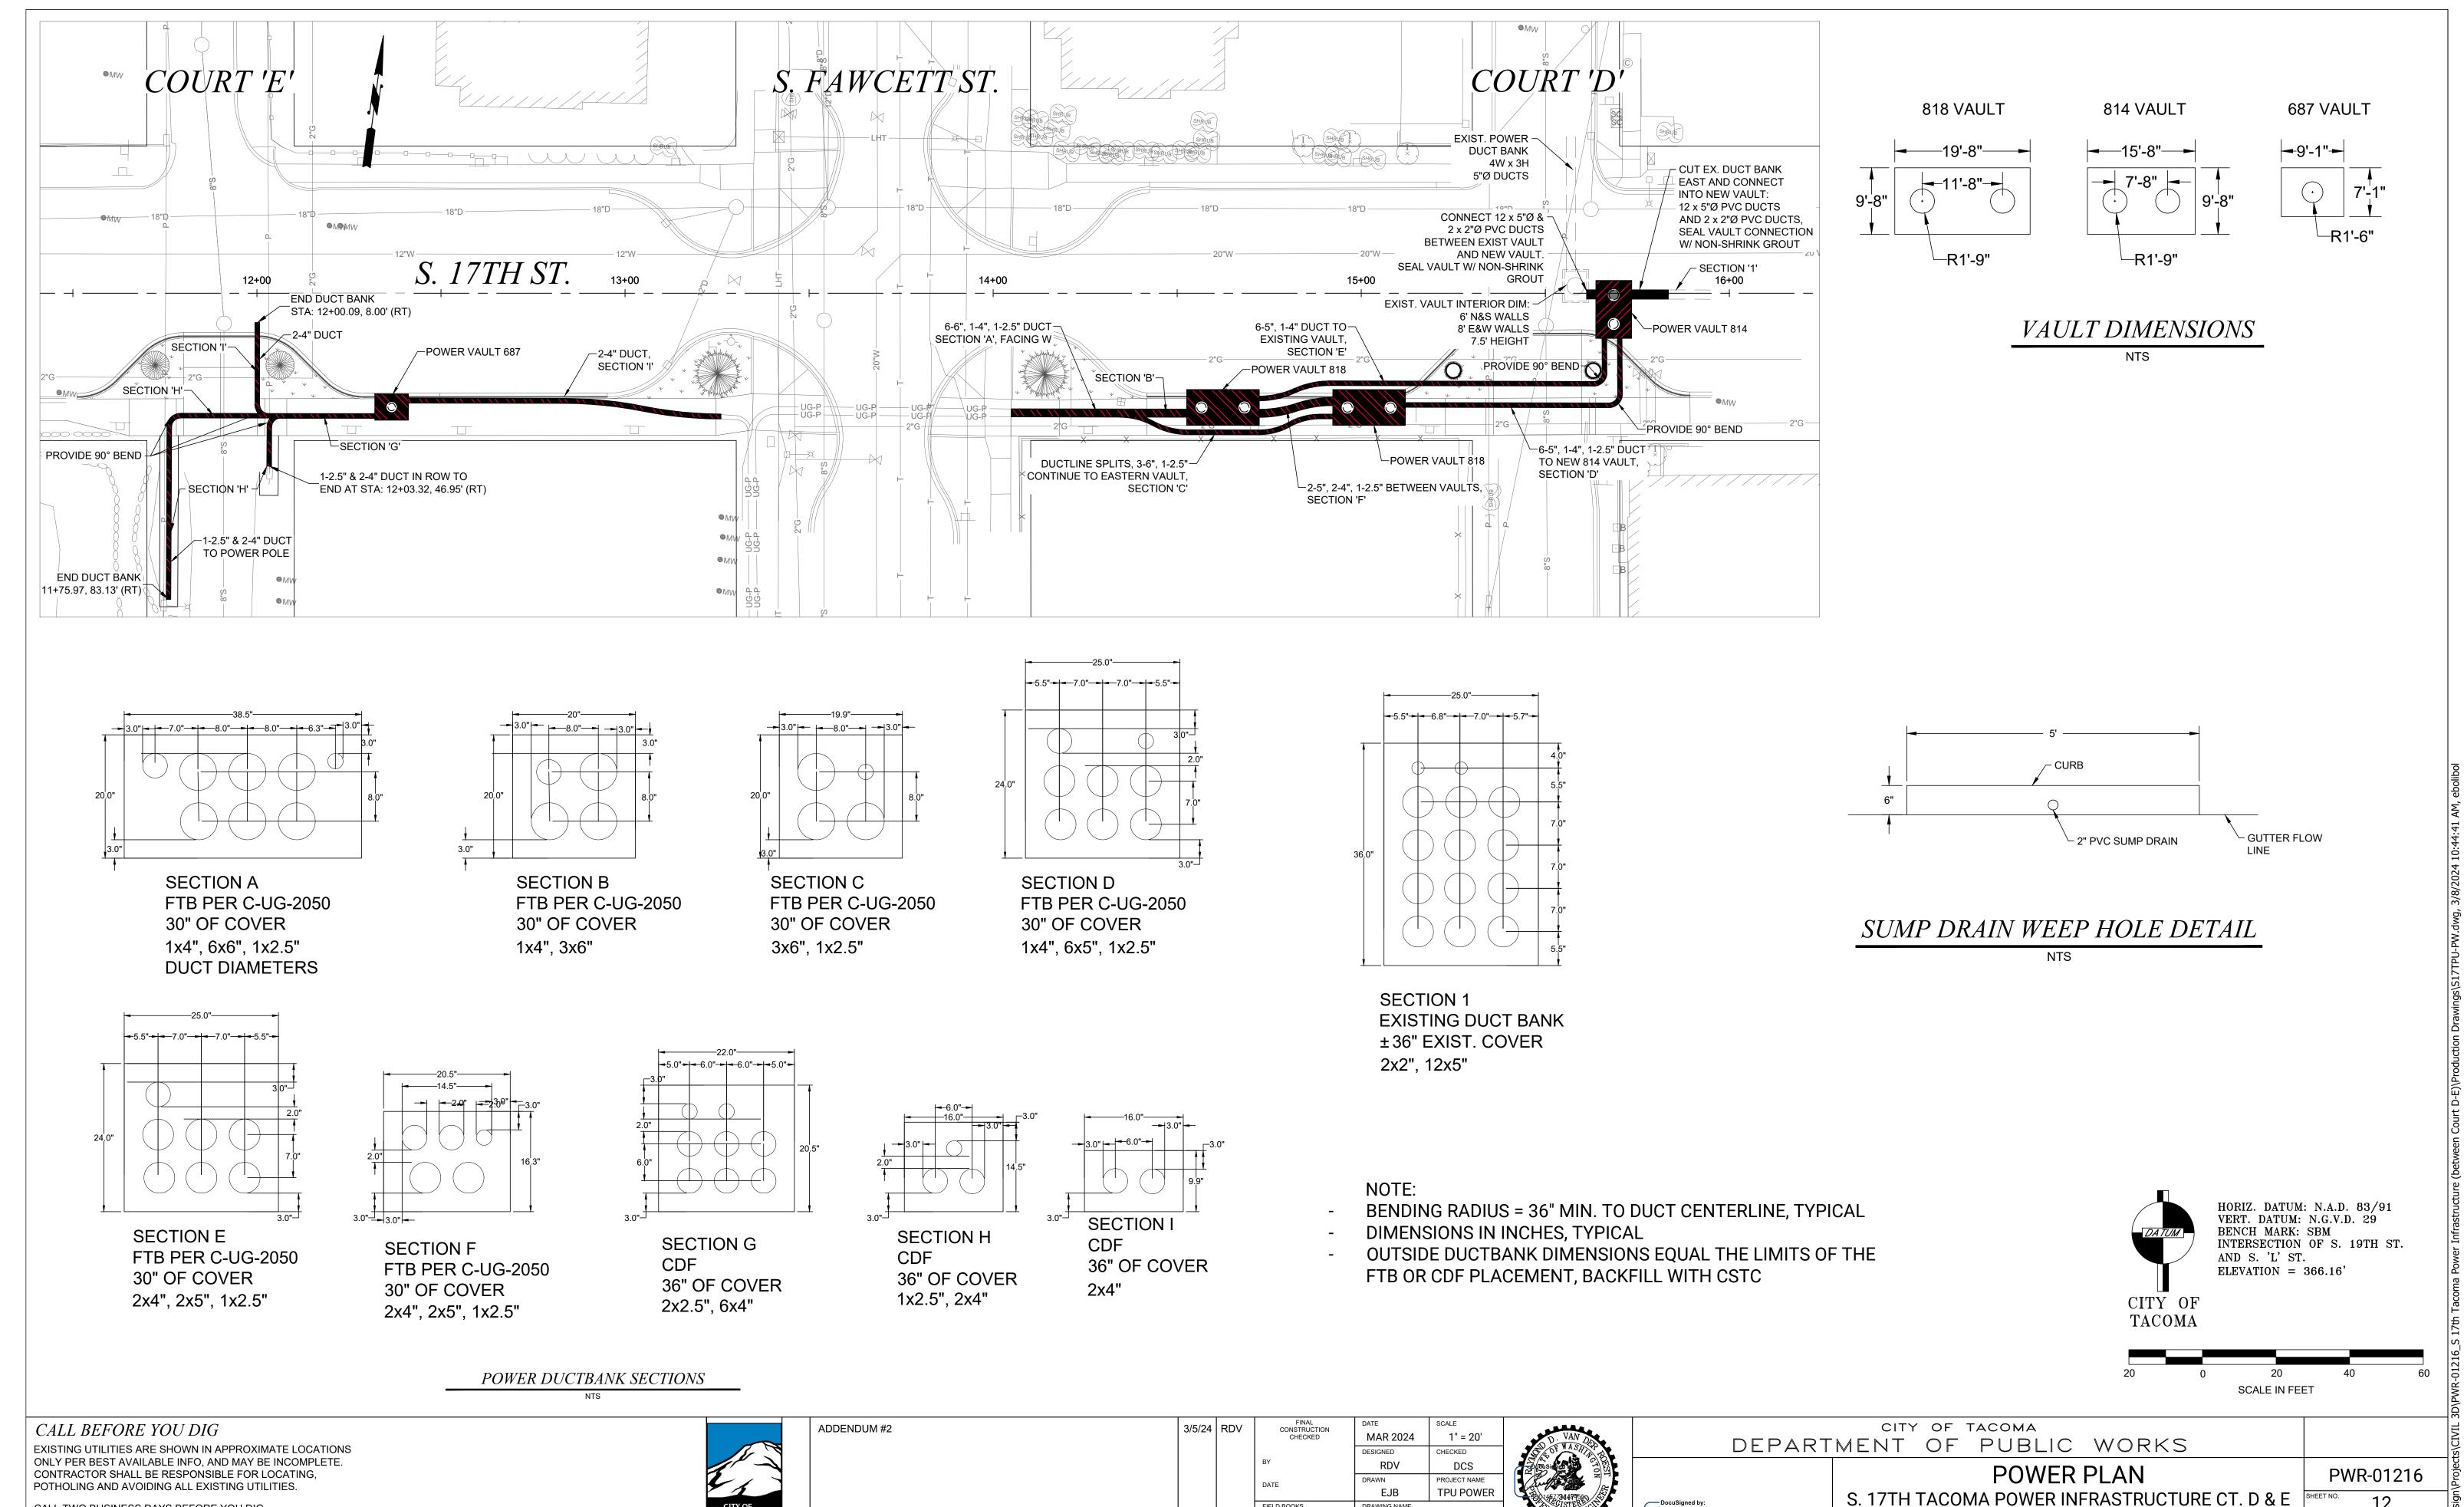

FIELD BOOKS

DATE APPD

REVISION

RAWING NAME

S17TPU-PW.DWG

03/08/2024 Jack Melinser

S. 17TH ST. FROM COURT D & E

ET PW-1 OF PW-1

CALL TWO BUSINESS DAYS BEFORE YOU DIG (1-800-424-5555) OR VISIT ONLINE: www.callbeforeyoudig.org 1 2 3

> 4 5

2-03 ROADWAY EXCAVATION AND EMBANKMENT (*****)

2-03.1 Description

The last sentence of the first paragraph is deleted.

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2-03.3 Construction Requirements

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This section is supplemented with the following:

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All roadway excavation shall be handled, hauled, and disposed of as contained-in determination (CID) contaminated material. The Contractor shall haul and dispose of all contaminated soil material excavated from the Project site in accordance with the Contract, Plans, and Specifications to LRI Landfill, located at 30919 Meridian Street East, Graham, WA 98338 in accordance with Special Provisions Section 2-17. The Contractor shall not include the cost of the disposal fees in the bid item. The City of Tacoma will pay the disposal fees directly to LRI.

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All soil from roadway excavation activities will be disposed of off site and shall be considered unsuitable fill material.

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2-03.3(5) Slope Treatment

22 This section is deleted.

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2-03.3(19) Removal of Pavement, Sidewalks, Curbs, and Gutters

This section is deleted.

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Section 2-03.3 is supplemented with the following:

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2-03.3(20) Field Adjustment

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(*****)

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Field adjustment involves adjustments to horizontal or vertical alignments, or vault elevations, that are shown in the plans or directed by the Engineer and will be performed as needed, by the Contractor, to address issues with drainage, utility vault construction, street crowning, cross slopes, curb ramps, and connections to existing grades for the finished product. The Contractor and the Engineer shall collaborate on field adjustment. All grade checking needed to complete the field adjustments shall be provided by the Contractor. The Contractor shall continue work, during the field adjustment time, in unaffected areas of the Project, in accordance with the Plans and Specifications. Some localized delay is inherent in this process, and the contractor shall be prepared to collaborate and move crews on to other work locations. For each field adjustment the City of Tacoma shall pay the Contractor by Force Account in accordance with Section 1-09.6. The contractor shall not be entitled to additional compensation due to delays from field adjustments.

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2-03.5 Payment

This section is supplemented with the following:

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"Roadway Excavation - CID Contaminated, Incl. Haul", per cubic yard.

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The unit Contract price per cubic yard for "Roadway Excavation - CID Contaminated, Incl. Haul" 1 2 shall be full compensation for all costs incurred for excavating, loading, disposal and haul of contained-in determination (CID) contaminated material to LRI Landfill. The Contractor shall not 3 include the cost of the disposal fees in the bid item. The City of Tacoma will pay the cost of the 4 5 disposal fees directly to LRI. 6 7 "Unsuitable Foundation Excavation - CID Contaminated, Incl. Haul", per cubic yard 8 9 The unit Contract price per cubic yard for "Unsuitable Foundation Excavation - CID Contaminated, Incl. Haul" shall be full compensation for all costs incurred for excavating below 10 subgrade per Section 2-03.3(14)E, loading, disposal and haul of contained-in determination 11 (CID) contaminated material to LRI Landfill. The Contractor shall not include the cost of the 12 disposal fees in the bid item. The City of Tacoma will pay the cost of the disposal fees directly 13 to LRI. 14 15 16 "Field Adjustment", by Force Account 17 18 19

8-40 POWER UTILITY WORK (*****)

8-40.1 Description

 This work shall consist of furnishing and installing power utility vaults, related structure excavation and trench excavation, installation of power duct banks with pull lines, and flowable thermal backfill placement (FTB). The City of Tacoma Power Utility crews shall install power cables and wiring in coordination with the Contractor.

8-40.2 Materials

Material Standards are according to Tacoma Power Standards. Applicable standards are included in the Appendix of these Contract Provisions.

 Power Vaults shall be installed in accordance with C-UG-1500. The Vaults available from some local suppliers may be slightly bigger in size, and can be 5000 lbs heavier. The Contractor shall be responsible to investigate the size and weight of vault components and provide shop drawings at least 5 days prior to the start of installation. The City of Tacoma may make adjustments to vault detail sheets for excavation limits and foundation elevations upon receiving shop drawings.

Electronic Tracer Ball: 3M EMS 1402 Electronic Tracer Ball or Tacoma Power approved equivalent.

8-40.3 Construction Requirements

Tacoma Power Utility standards as included in the appendix shall govern. Otherwise trench excavation, structure excavation, and installation of conduits and structures shall be in accordance with Sections 2-09, 7-05, and 7-08, 8-20, 9-29 while Section 8-40 shall govern.

Power Duct banks, Power Vaults, and trench excavation shall be in accordance with the Plans and Specifications, and Tacoma Power Utility standards. All conduits and ducts shall be installed with pull lines.

Vaults:

The Contractor shall install Power Utility Vaults in accordance with the Plans, Tacoma Power Standards, and these Special Provisions. Construct a 8-inch compacted thickness, level foundation pad under the entire vault, extending 1-foot out from the vault base. The foundation pad shall be constructed with crushed surfacing top course (CSTC) compacted to at least 95% of maximum density in accordance with Section 4-04.3. The Contractor shall adjust the lids and covers to finished grade, and install a single 2" sump drain for pump connection at each vault from existing knockout through the new curb to empty to the gutter flow line. A sump drain detail is included in the Plans.

Where new duct banks are connected to a new vault per the Plans, the Contractor shall use the vault knock-outs to make an opening and extend the ducts including pull-lines into the vault.

The opening shall be cemented and sealed with non-shrink Grout Type 2 or Mortar Type 3 per WSDOT Standard Specifications Sections 9-20.3(2) and 9-20.4(4).

Structure Excavation, Vaults, Trenches, and Duct Banks:

The Contractor shall haul and dispose of all contaminated soil material excavated from the Project site in accordance with the Contract, Plans, and Specifications to LRI Landfill, located at 30919 Meridian Street East, Graham, WA 98338 in accordance with Special Provisions Section 2-17.

Structure Excavation Class B horizontal paylimits shall coincide with duct bank dimensions including the CDF or FTB volume. The lower paylimits shall be the bottom of CSTC foundation under a vault and coincide with the bottom of a duct bank including the CDF or FTB volume.

The upper trench excavation pay limits shall be the existing ground surface or the bottom of any

17 sidewalk or other pavement removal.

Structure Excavation for vaults shall be in accordance with Sections 2-09, and shall be included in the quantity for "Structure Excavation Class B Incl. Haul____", per cubic yard. **Horizontal** paylimits for Structure Excavation for Vaults shall be at 2 foot horizontal distance from the outside of the vault wall.

Power duct banks shall be encased in Flowable Thermal Backfill (FTB) or CDF to a depth in accordance with the Plans and these Special Provisions. The outside dimensions of each duct bank section as shown in the Plans define the limits for FTB or CDF placement. The remainder of the back fill shall be crushed surfacing top course (CSTC). Install an Electronic Tracer Ball in the topmost, centermost duct at locations where newly built conduit banks do not terminate into a vault.

Connect Existing Ductbank into new Vault

The Contractor shall connect an existing duct-bank into a new vault where shown per the Plans. At these locations the Contractor shall cut the existing duct-bank upto 10 feet from the proposed vault wall or as necessary for installing the new vault and extending the ducts into the vault.

 The final construction scenario will be dependent on the actual depth of the conduits within the ductbank, and the Contractor shall field adjust the design detail in coordination with the Engineer. This may involve reversing vault top and bottom section, installing conduit connections into the vault wall, adjusting the vault foundation elevation, or installing PVC bends in conduits to line up with the connection points. The City will pay for any field adjustments by force account under "Field Adjustment" in accordance with these Special Provisions and Section 2-03.

The City will pay for any changes that result in additional Vault customization that is not shown per Plans for new or existing vaults under "Minor Change" by Force Account.

Specification No. PW23-0090F ADDENDUM #2

Page 3 of 4

8-40.4 Measurement 1 2 3 "Connect Existing Ductbank into new Vault", shall be measured per each new vault wall where a ductbank connection is constructed into the vault including all duct extensions. 4 5 6 Power Utility Vault shall be measured per each vault furnished and installed in accordance with 7 the Plans and Specifications, and Tacoma Power Utility standards. 8 9 Conduit Bank "shall be measured per linear foot along the alignment of the power conduit 10 bank trench. 11 Flowable Thermal Backfill (FTB) and CDF shall be included in the measurement per linear foot 12 for " Conduit Bank". 13 14 15 "Electronic Tracer Ball" shall be measured per each tracer ball installed in accordance with these Special Provisions and TPU Power Standards. 16 17 18 "Structure Excavation Class B Incl. Haul" shall be measured per cubic yard in place before 19 excavation to the paylimits per Section 8-40.3. 20 21 8-40.5 Payment 22 23 "Connect Existing Ductbank into new Vault", per Each 24 25 The Contract unit price per each for "Connect Existing Ductbank into new Vault" shall be full 26 compensation for all labor, equipment and materials to cut and remove and dispose of the 27 existing duct bank as necessary per Plans and Specifications, to make an adequate opening in the vault wall, and to connect and extend existing ducts with new duct lengths, including pull 28 lines, into the new vault per the TPU Power Standards, and to cement and seal the opening per 29 30 the Special Provisions and Specifications. 31 32 The City will pay for any field adjustments by force account under "Field Adjustment" in accordance with these Special Provisions and Section 2-03. 33 34 35 The City will pay for any changes that result in additional Vault customization that is not shown per Plans for new or existing vaults under "Minor Change" by Force Account. 36 37 "Power Utility ____Vault" per Each 38 39 The Contract price per each for Power Utility ____Vault shall be full compensation for all labor, 40 tools, equipment, and materials to furnish and install the complete vault, including single 2" 41 42 sump line, to cement and seal duct connections, and to adjust the lids and covers to finished grade all in accordance with the Plans, Special Provisions and Specifications. 43 44 45 "Power Utility 818 Vault", per each 46 "Power Utility 814 Vault", per each 47 48 49 "Power Utility 687 Vault", per each

1 2	"Conduit Bank", per linear foot
3	
4 5 6 7	The Contract price per linear foot for "Conduit Bank" shall be full compensation for all labor, tools, equipment, and materials to install the power conduit bank including pull lines and FTB, and to construct connections into the vaults, all in accordance with TPU Power Standards, the Plans, Special Provisions and Specifications. The outside dimensions of each duct bank section
8	as shown in the Plans define the pay-limits for FTB.
9	· ·
10	"Section A Conduit Bank", per linear foot
11	
12	"Section B Conduit Bank", per linear foot
13	"Castian C Canduit Bank" par linear fact
14 15	"Section C Conduit Bank", per linear foot
16	"Section D Conduit Bank", per linear foot
17 18	"Section E Conduit Bank", per linear foot
19 20	"Section F Conduit Bank", per linear foot
21 22	"Section G Conduit Bank", per linear foot
23 24 25	"Section H Conduit Bank", per linear foot
26 27	"Section I Conduit Bank", per linear foot
28 29	"Electronic Tracer Ball", per Each
30 31	The Contract price per each for Electronic Tracer Ball shall be full compensation for all labor, tools, equipment, and materials to furnish and install the electronic tracer ball.
32	, 1 1 ,
33	
34	END OF SECTION
35	

BID PROPOSAL

SPECIFICATION NO. PW23-0090F ADDENDUM #2

TPU S 17th Street Court D/E Project

The undersigned hereby certifies that he/she has examined the location and construction details of work as outlined on the Plans and Specifications for Project No. **PWR-01216** and has read and thoroughly understands the Plans and Specifications and contract governing the work embraced in this improvement and the method by which payment will be made for said work, and hereby proposes to undertake and complete the work embraced in this improvement in accordance with said Plans, Specifications and contract and at the following schedule of rates and prices:

NOTE: 1. Unit prices of all items, all extensions and total amount of bid should be shown. Show unit prices in figures only.

2. The notations below the item numbers refer to the specification section where information may be found regarding each contract item. These notations are intended only as a guide and are not warranted to refer to all specification sections where information may be found.

The bid items are grouped as follows:

Group R: Roadway Bid Items

Group P: Power Utility Bid Items

Group L: Lump Sum Bid Items

Summarize totals as indicated on the pages that follow below:

Group-R: TPU S 17th Street Court D/E Project Roadway Bid Items R-1 through R-28 Specification No. PW23-0090F ADDENDUM #2

ITEM NO.	ITEM DESCRIPTION	ESTIMATE QUANTITY	UNIT PRICE	TOTAL AMOUNT
R- 1 2-02	Test Hole, per linear foot	100 LF	\$	\$
R- 2 2-03	Roadway Excavation - CID Contaminated, Incl. Haul, per cubic yard	230 CY	\$	\$
R- 3 2-03	Unsuitable Foundation Excavation - CID Contaminated, Incl. Haul, per cubic yard	20 CY	\$	\$
R- 4 2-09	Structure Excavation Class B Incl. Haul - CID Contaminated, per cubic yard	730 CY	\$	\$
R- 5 2-09	Shoring Class B, per square foot	3,320 SF	\$	\$
R- 6 2-09	Extra Excavation Class B, CID Contaminated, per cubic yard	100 CY	\$	\$
R- 7 2-14	Remove Existing Pavement, Type I, Class C6, per square yard	270 SY	\$	\$
R- 8 2-14	Remove Existing Pavement, Type I, Class CA, per square yard	530 SY	\$	\$
R- 9 2-15	Remove Curb, per linear foot	293 LF	\$	\$
R- 10 4-04	Crushed Surfacing Top Course, per ton	1,000 TN	\$	\$

Contractor's Name:		

Specification Number: PW23-0090F ADDENDUM #2

Group R, Page 1 of 3

ITEM NO.	ITEM DESCRIPTION	ESTIMATE QUANTITY	UNIT PRICE	TOTAL AMOUNT
R- 11 4-04	Recycled Concrete Aggregate, per ton	150 TN	\$	\$
R- 12 5-04	Planing Bituminous Pavement, per square yard	520 SY	\$	\$
R- 13 5-04	Temporary Pavement Patch, per ton	20 TN	\$	\$
R- 14 5-04	Fiber Reinforced HMA CL 1/2" PG 58H-22, per ton	160 TN	\$	\$
R- 15 7-05	Adjust Existing Manhole, Furnish New Frame and Cover, per each	2 EA	\$	\$
R- 16 8-02	PSIPE Accolade elm, per each	2 EA	\$	\$
R- 17 8-02	PSIPE hardy rubber tree, per each	2 EA	\$	\$
R- 18 8-02	PSIPE American Yellowwood, per each	2 EA	\$	\$
R- 19 8-04	Cement Conc. Traffic Curb and Gutter, per linear foot	350 LF	\$	\$
R- 20 8-06	Cement Conc. Driveway Entrance, per square yard	180 SY	\$	\$
R- 21 8-14	Cement Conc. Sidewalk, per square yard	320 SY	\$	\$

Contractor's	Name:			

Specification Number: PW23-0090F ADDENDUM #2

Group R, Page 2 of 3

ITEM NO.	ITEM DESCRIPTION		ESTIMATE QUANTITY	UNIT PRICE		TOT	ΓAL OUNT	
R- 22 8-15	Quarry Spalls, per ton		10 TN	\$ 		\$		
R- 23 8-20	Install Conduit, 2-inch Dia 80, with Pull Line, per line		330 LF	\$		\$		
R- 24 8-20	Install Type 1 Junction Box	x, per each	4 EA	\$		\$		
R- 25 8-22	Paint Line, per linear foot		400 LF	\$ 		\$		
	l, Group R Item Nos. R-1 through	R-25			\$			_ (1)
R 26 2-03	Field Adjustment		Force Account	Estimated	\$ 1	0,000.00	(2)	
R 27 1-04.4	Minor Change		Force Account	Estimated	\$ 10	0,000.00	(3)	
R 28 8-01	Dewatering		Force Account	Estimated	\$ 1	0,000.00	(4)	
Total, Gi	roup R	(1)+(2)+(3)+(4)			\$			(5)

Contractor's Name:		

Specification Number: PW23-0090F ADDENDUM #2

Group R, Page 3 of 3

Group-P: TPU S 17th Street Court D/E Project Power Bid Items P-1 through P-14 Specification No. PW23-0090F ADDENDUM #2

ITEM NO.	ITEM DESCRIPTION	ESTIMATE QUANTITY	UNIT PRICE	TOTAL AMOUNT
P- 1 8-40	Power Utility 818 Vault, per each	2 Each	\$	\$
P- 2 8-40	Power Utility 814 Vault, per each	1 Each	\$	\$
P- 3 8-40	Power Utility 687 Vault, per each	1 Each	\$	\$
P- 4 8-40	Section A Conduit Bank, per linear foot	35 Lin. Ft.	\$	\$
P- 5 8-40	Section B Conduit Bank, per linear foot	15 Lin. Ft.	\$	\$
P- 6 8-40	Section C Conduit Bank, per linear foot	55 Lin. Ft.	\$	\$
P- 7 8-40	Section D Conduit Bank, per linear foot	80 Lin. Ft.	\$	\$
P- 8 8-40	Section E Conduit Bank, per linear foot	110 Lin. Ft.	\$	\$
P- 9 8-40	Section F Conduit Bank, per linear foot	22 Lin. Ft.	\$	\$

Contractor's Name:			

Specification Number: PW23-0090F ADDENDUM #2

Group P, Page 1 of 2

ITEM NO.	ITEM DESCRIPTION	ESTIMATE QUANTITY		NIT LICE	TOTAL AMOUNT	
P- 10 8-40	Section G Conduit Bank, per linear foot	30 Lin. Ft.	\$		\$	
P- 11 8-40	Section H Conduit Bank, per linear foot	95 Lin. Ft.	\$		\$	
P- 12 8-40	Section I Conduit Bank, per linear foot	108 Lin. Ft.	\$		\$	
P- 13 8-40	Connect Existing Ductbank into new Vault, per Each	2 Each	\$		\$	
P- 14 8-40	Electronic Tracer Ball, per Each	3 Each	\$		\$	
	l, Group P Item Nos. P-1 through P-14			\$	-1	(6)
	10.3% Sales Tax on Power Bid Items	(6)	* 0.103	\$		(7)
	Total, Group P	(6) + (7)	\$		(8)

Contractor's Name:	<u> </u>		

Specification Number: PW23-0090F ADDENDUM #2

Group-L: TPU S 17th Street Court D/E Project Lump Sum Bid Items L-1 through L-13 Specification No. PW23-0090F ADDENDUM#2

ITEM NO.	ITEM DESCRIPTION	ESTIMATE QUANTITY	UNIT PRICE	TOTAL AMOUNT
L- 1 1-05	Project Red Line Drawings	1 Lump Sum	LUMP SUM	\$
L- 2 1-07	SPCC Plan	1 Lump Sum	LUMP SUM	\$
L- 3 1-09	Mobilization	l Lump Sum	LUMP SUM	\$
L- 4 1-10	Pedestrian Traffic Control	1 Lump Sum	LUMP SUM	\$
L- 5	Project Temporary Traffic Control	1 Lump Sum	LUMP SUM	\$
L- 6 2-06	Subgrade Maintenance and Protection	1 Lump Sum	LUMP SUM	\$
L- 7 2-17	Site Health and Safety Plan	1 Lump Sum	LUMP SUM	\$
L- 8 2-17	Site Health and Safety Officer	1 Lump Sum	LUMP SUM	\$
L- 9 2-17	Soil Management Plan	1 Lump Sum	LUMP SUM	\$
L- 10 8-01	Erosion Control and Water Pollution Prevention	1 Lump Sum	LUMP SUM	\$

Contractor's Name:		

Specification Number: PW23-0090F ADDENDUM #2

Group L, Page 1 of 2

NO.	ITEM DESCRIPTION	ESTIMATE QUANTITY	UNIT PRICE	TOTAL AMOUNT	
L- 11 8-01	Stormwater Pollution Prevention Plan (SWPPP)	1 Lump Sum	LUMP SUM	<u>\$</u>	
L- 12 8-02	Roadside Restoration	l Lump Sum	LUMP SUM	\$	
L- 13 8-21	Permanent Signing	1 Lump Sum	LUMP SUM	\$	
Total, G	Group L n Nos. L-1 through L-13		\$		(9)

Contractor's Name:

BID TOTALS SUMMARY, ADDENDUM #2:

GROUP R: Roadway Bid Items

GROUP P: Power Bid Items

GROUP P SUB TOTAL (excluding sales tax)

GROUP L: Lump Sum Bid Items

GROUP L TOTAL

\$ (6)

TOTAL BASE BID (5) + (6) + (9)

Excluding sales tax

Proposal for Inco	porating Recycled Materials into the Project				
n compliance with RCW 70A.205.700, the Bidder shall propose below, the total percent of construction aggregate and concrete materials to be incorporated into the Project that are ecycled materials. Calculated percentages must be within the amounts allowed in Section 9-03.21(1)E, Table on Maximum Allowable Percent (By Weight) of Recycled Material, of the Standard Specifications.					
Proposed total percentage:	percent.				
not constitute a Bidder Preference more lowest responsive Bid totals percentages will be used as a tie- Provisions. Regardless, the Bidd Contractor should do its best to a	s highly encouraged within the limits shown above, but does e, and will not affect the determination of award, unless two or are exactly equal, in which case proposed recycling breaker, per the APWA GSP in Section 1-03.1 of the Special er's stated proposed percentages will become a goal the eccomplish. Bidders will be required to report on recycled to the Project, in accordance with the APWA GSP in Section				
Bidder:					
Signature of Authorized Official:					
Date:					